

PROPOSED SIRWA AGGREGATION CENTER LAYOUT


COORDINATES= 0.187044N, 35.774995E




PROPOSED SIRWA AGGREGATION CENTER LAYOUT

COORDINATES= 0.187044N, 35.774995E

REV.	DESCRIPTION:	DATE:	DRAWN BY:	DESIGNED BY:	CLIENT:	PROJECT: PROPOSED SIRWA AGGREGATION CENTER IN MOGOTIO CONSTITUENCY, BARINGO COUNTY
A.	FIRST ISSUE	DEC, 2024	Francis K. Ngigi	1. Eng. Amos Kiptanui	State Department of Agriculture Ministry of Agriculture and Livestock Development, Cathedral Road, Nairobi P. O. Box 30028-00100 Nairobi- Kenya	
						TITLE: MAIN LAYOUT
				CHECKED BY:		DRG NO: MoALD/SIR/001
				1. Eng. Laban Kiplagat		SCALE: As Shown
						Contract NO:
						Sheet: A Sheet

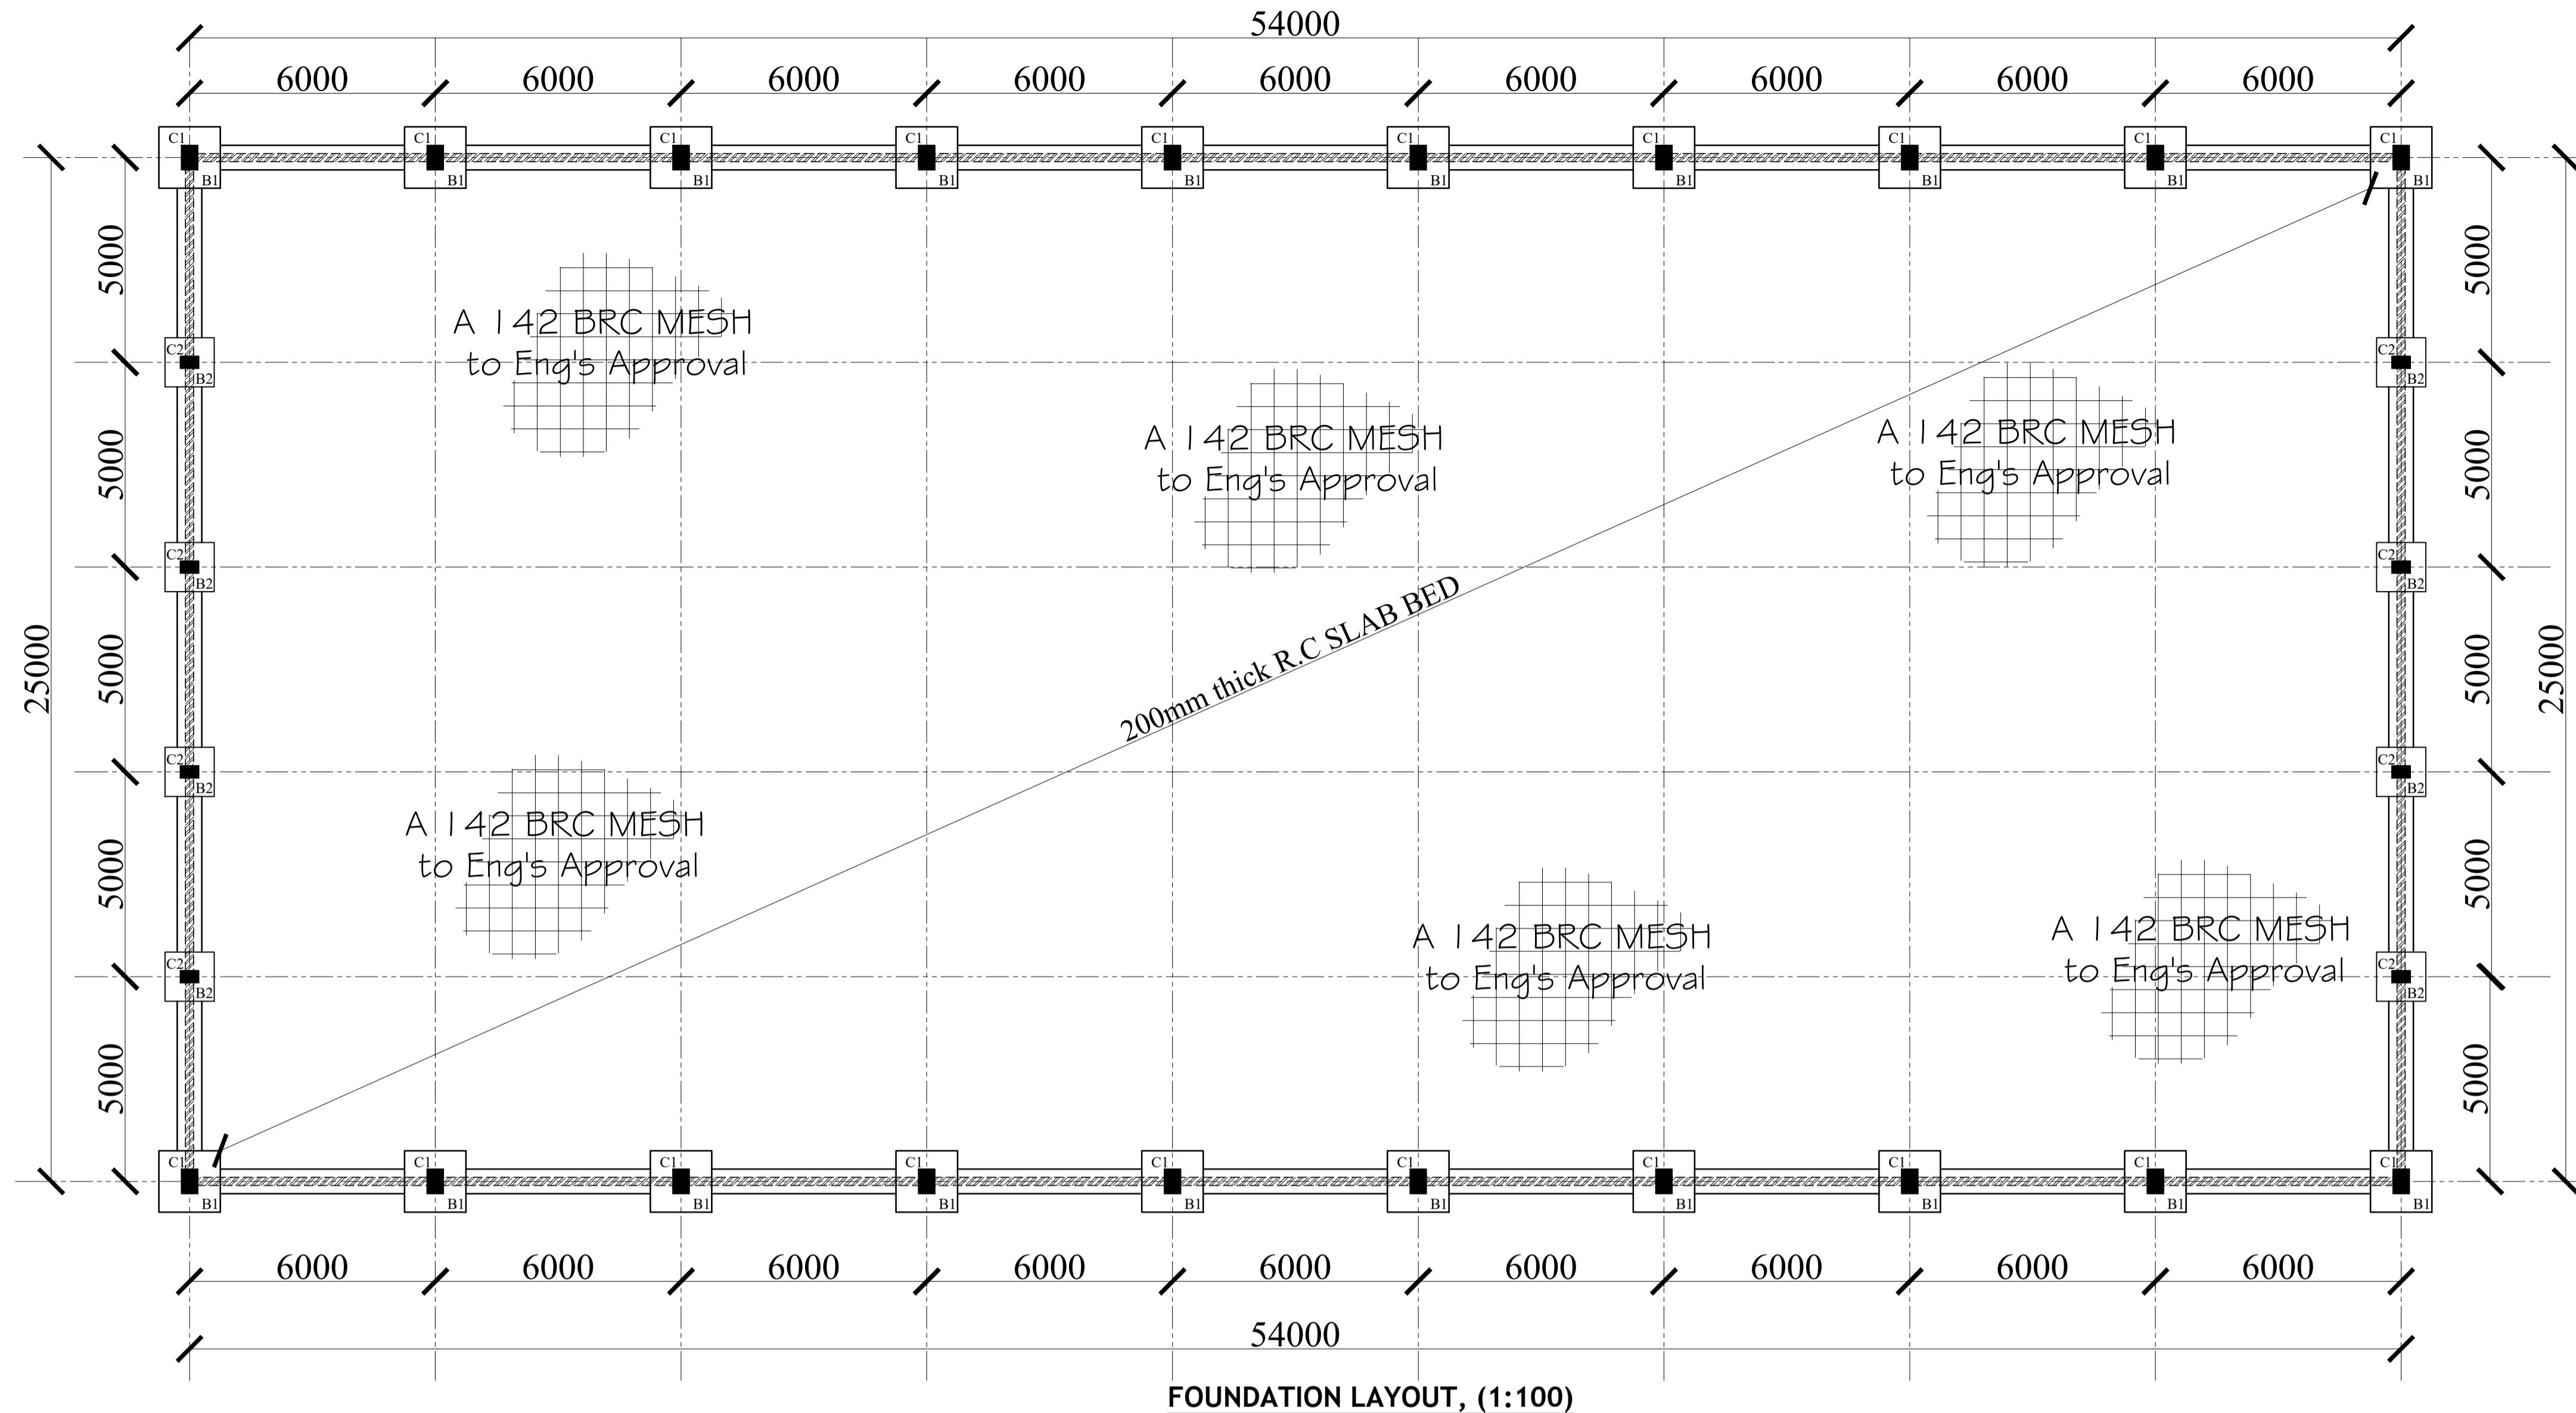


FOUNDATION LAYOUT, (1:100)

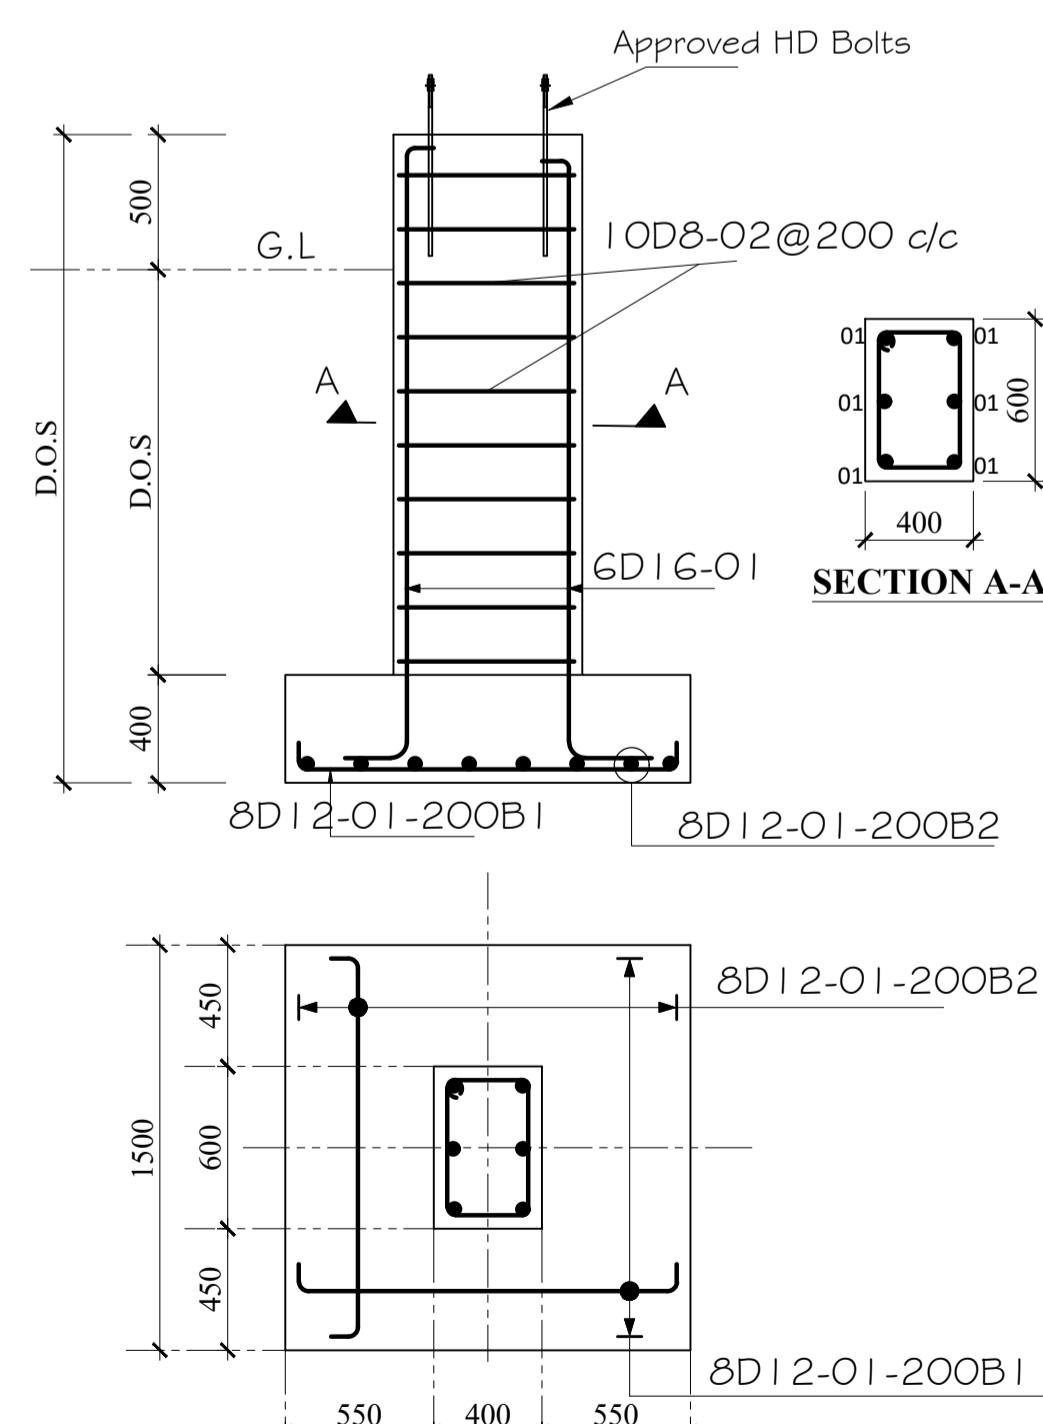


COLUMN (1)/BASE (1) DETAILS

(Scale- 1 :50)

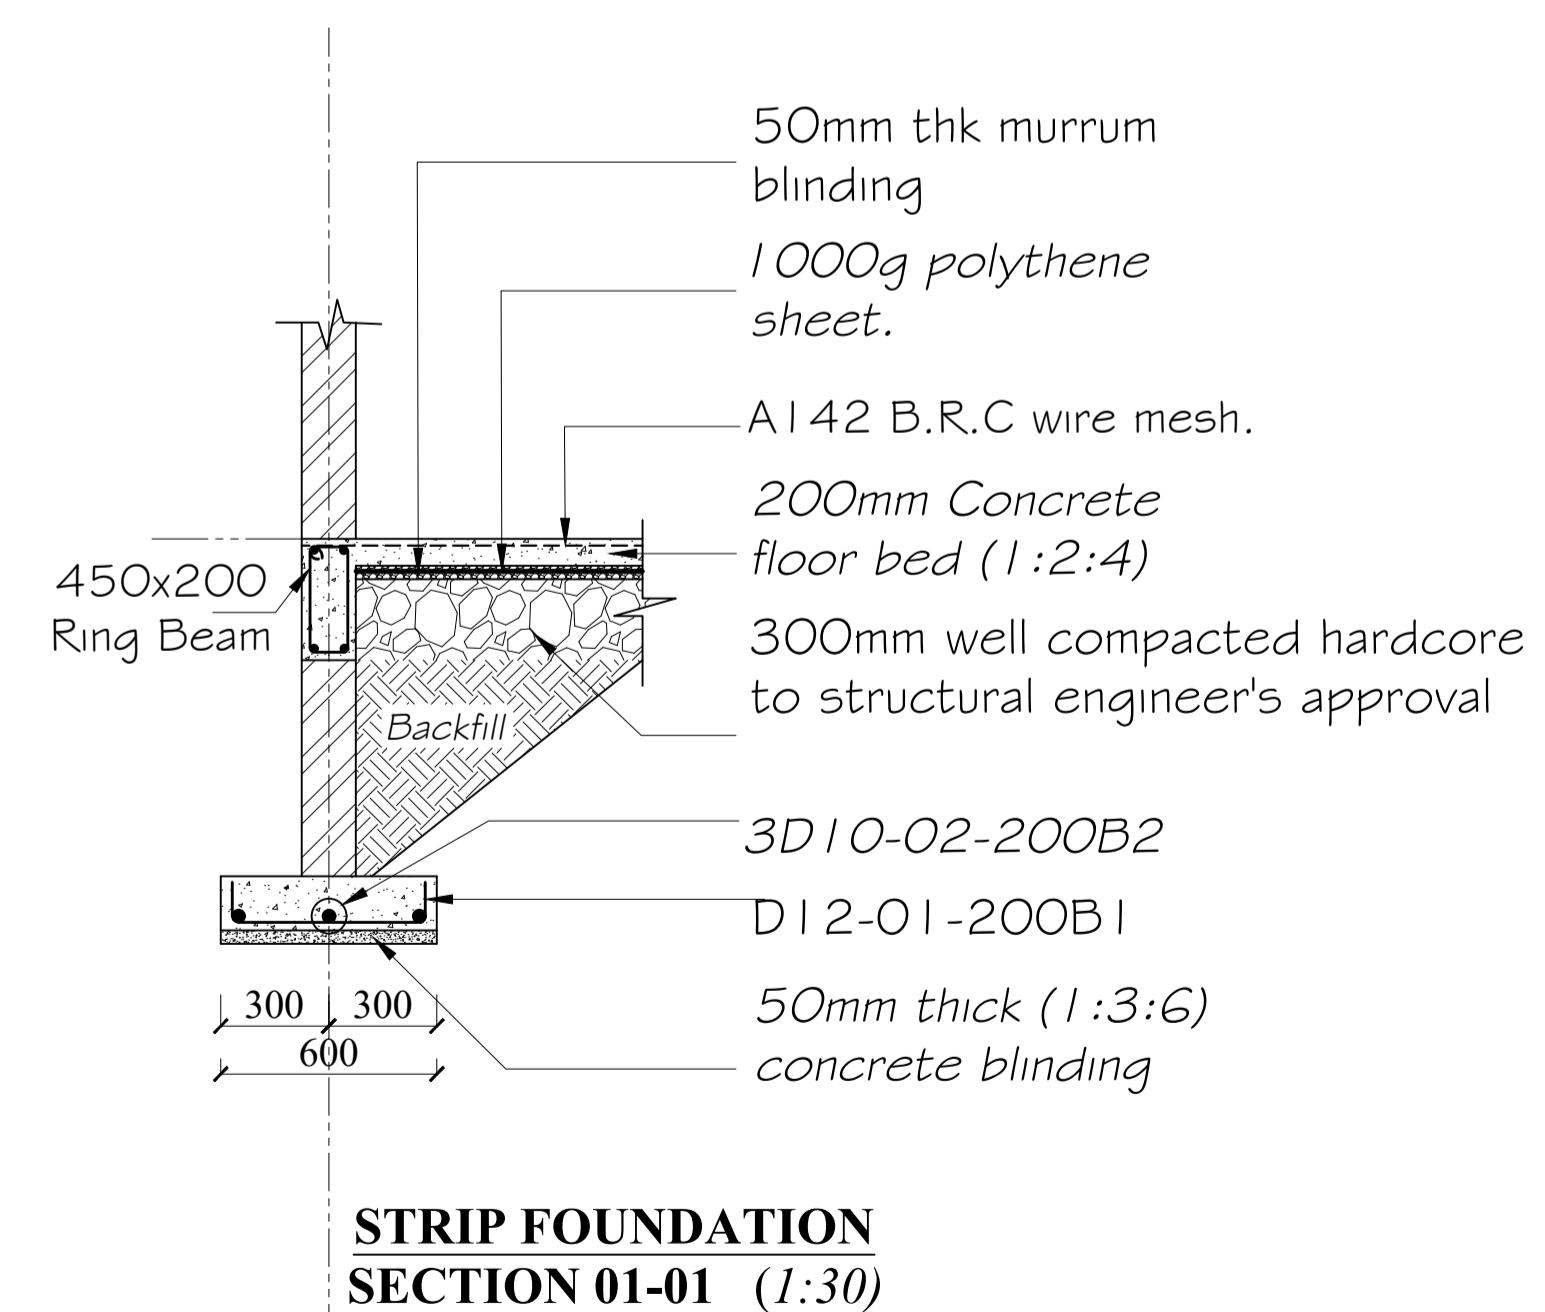


STRIP FOUNDATION SECTION 01-01 (1:30)

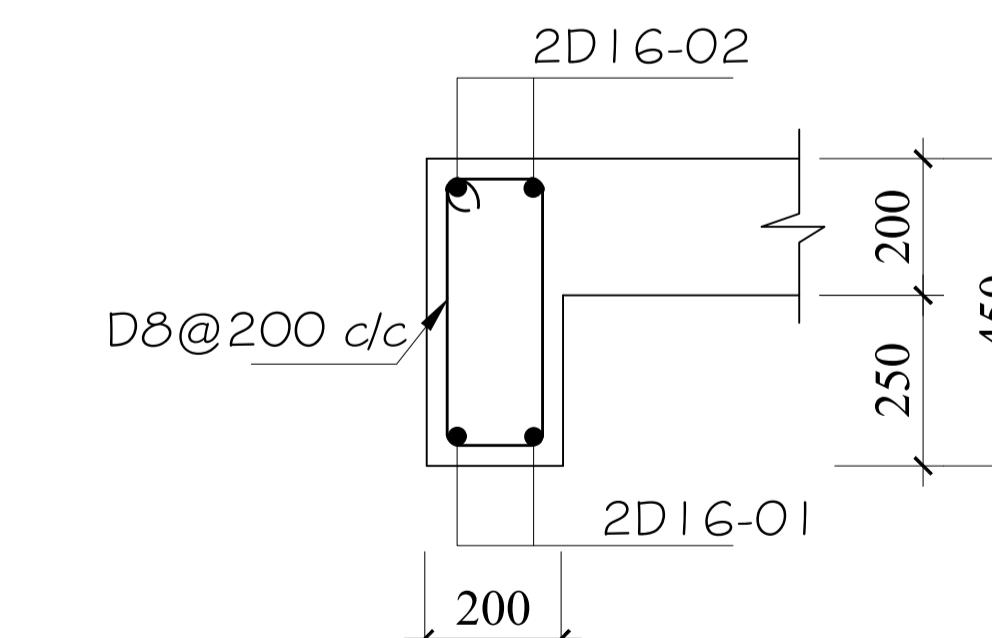


450X200mm RING BEAM


Section through Ring beam

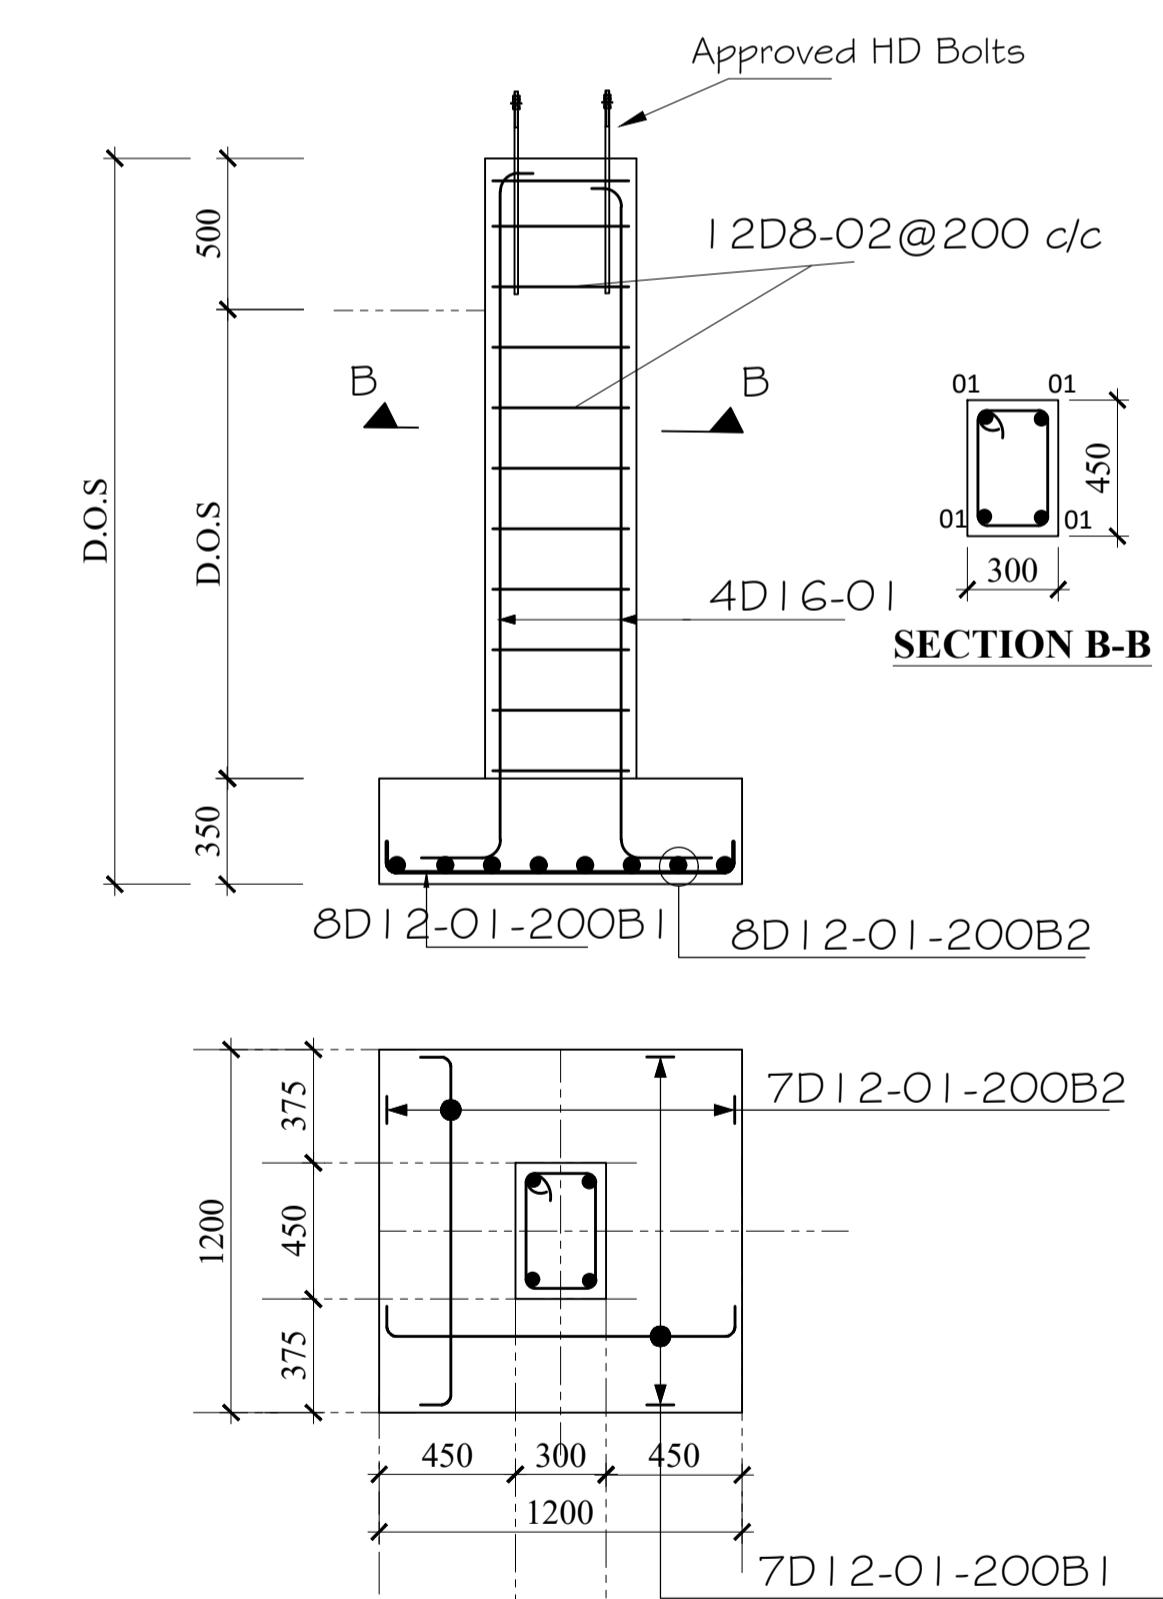

COLUMN (2)/BASE (2) DETAILS

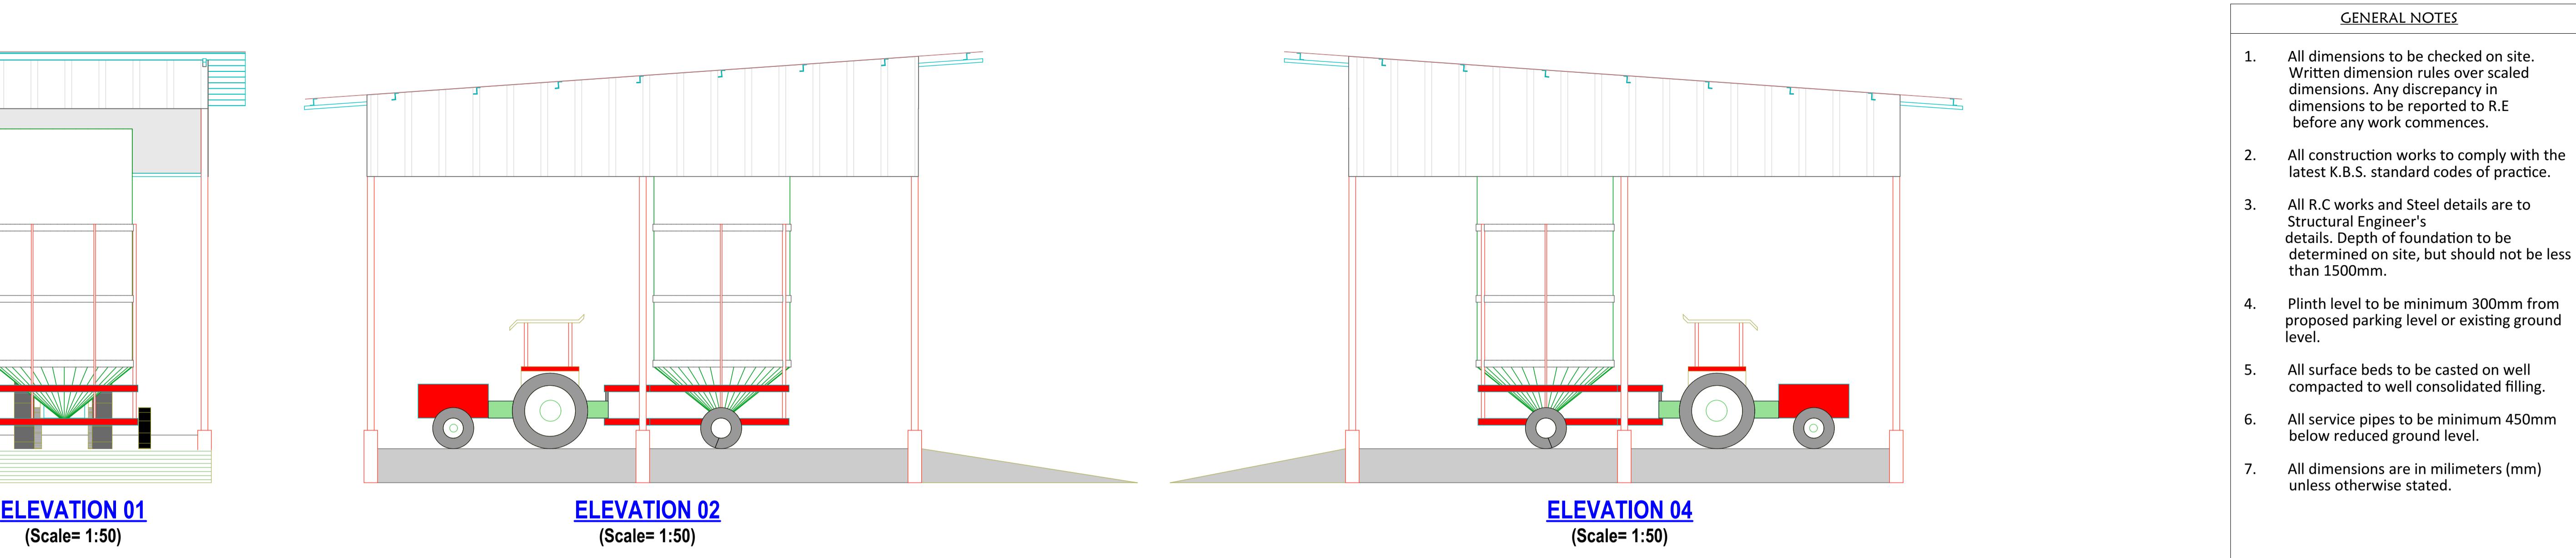


GENERAL NOTES	
1.	All dimensions to be checked on site. Written dimension rules over scaled dimensions. Any discrepancy in dimensions to be reported to R.E before any work commences.
2.	All construction works to comply with the latest K.B.S. standard codes of practice.
3.	All R.C works and Steel details are to Structural Engineer's details. Depth of foundation to be determined on site, but should not be less than 1500mm.
4.	Plinth level to be minimum 300mm from proposed parking level or existing ground level.
5.	All surface beds to be casted on well compacted to well consolidated filling.
6.	All service pipes to be minimum 450mm below reduced ground level.
7.	All dimensions are in millimeters (mm) unless otherwise stated.

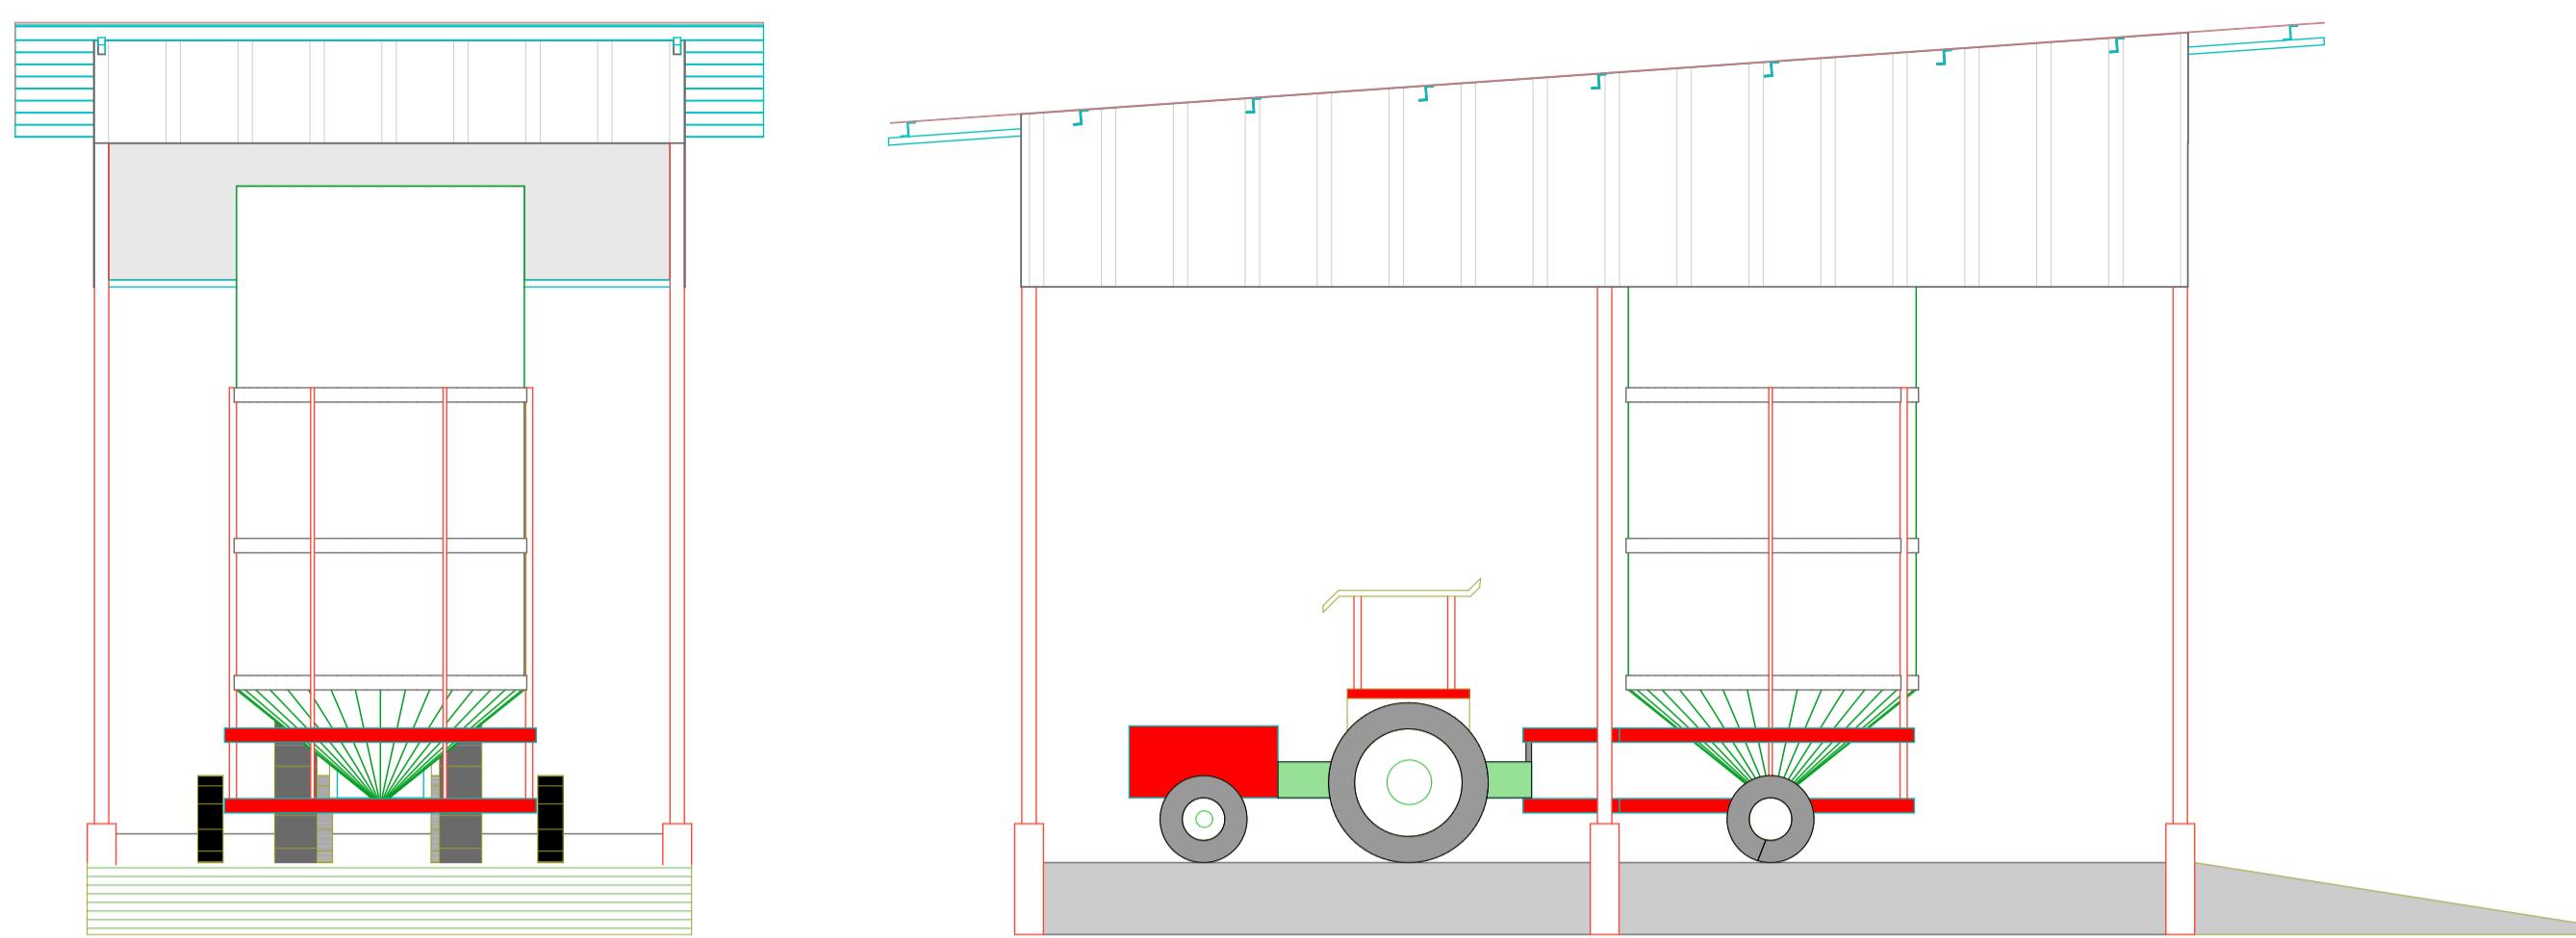


ELEVATION 01

(Scale= 1:50)

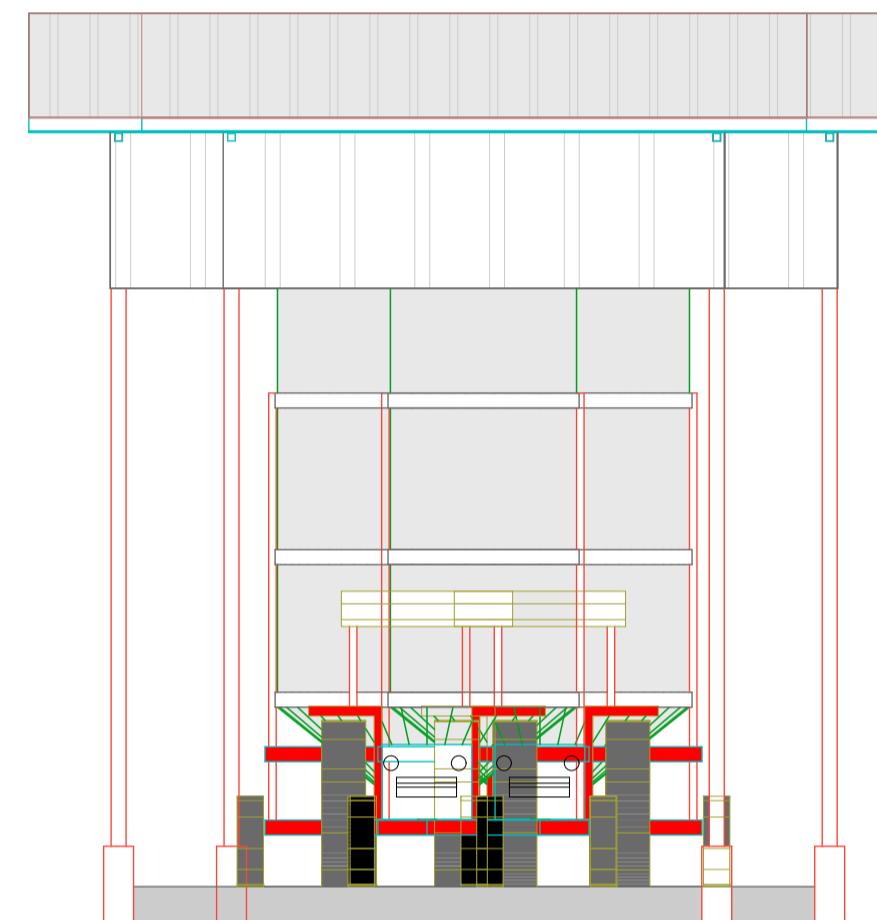


ELEVATION 02

(Scale= 1:50)

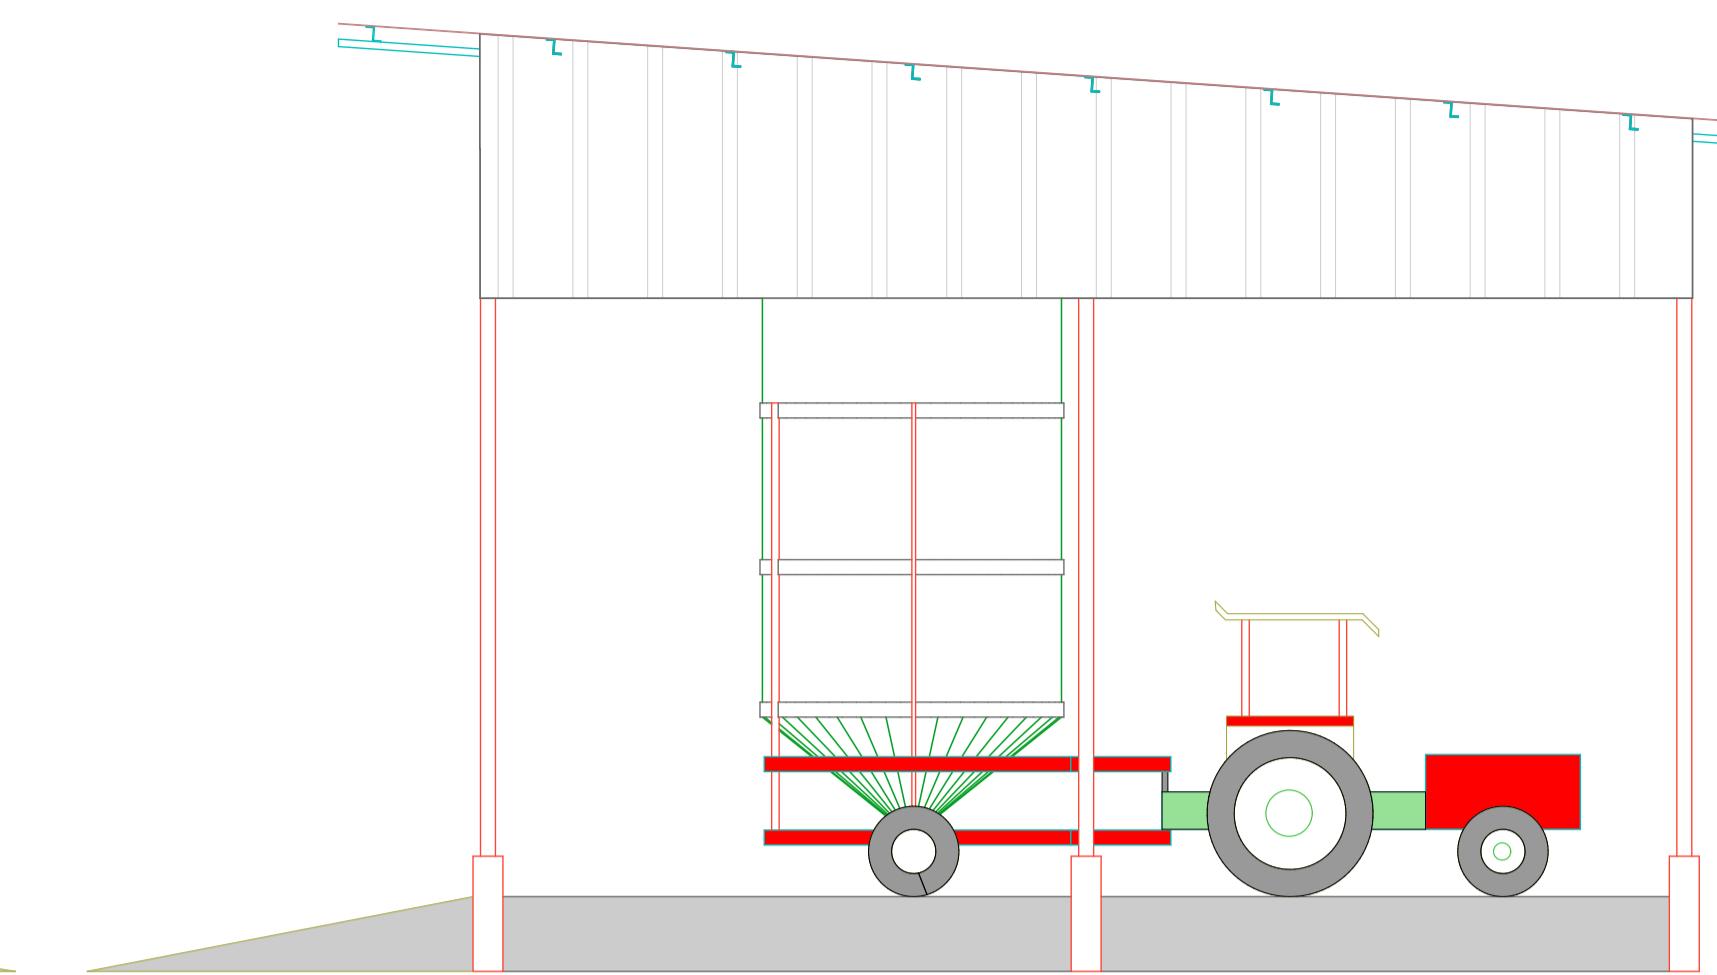


ELEVATION 04

(Scale= 1:50)

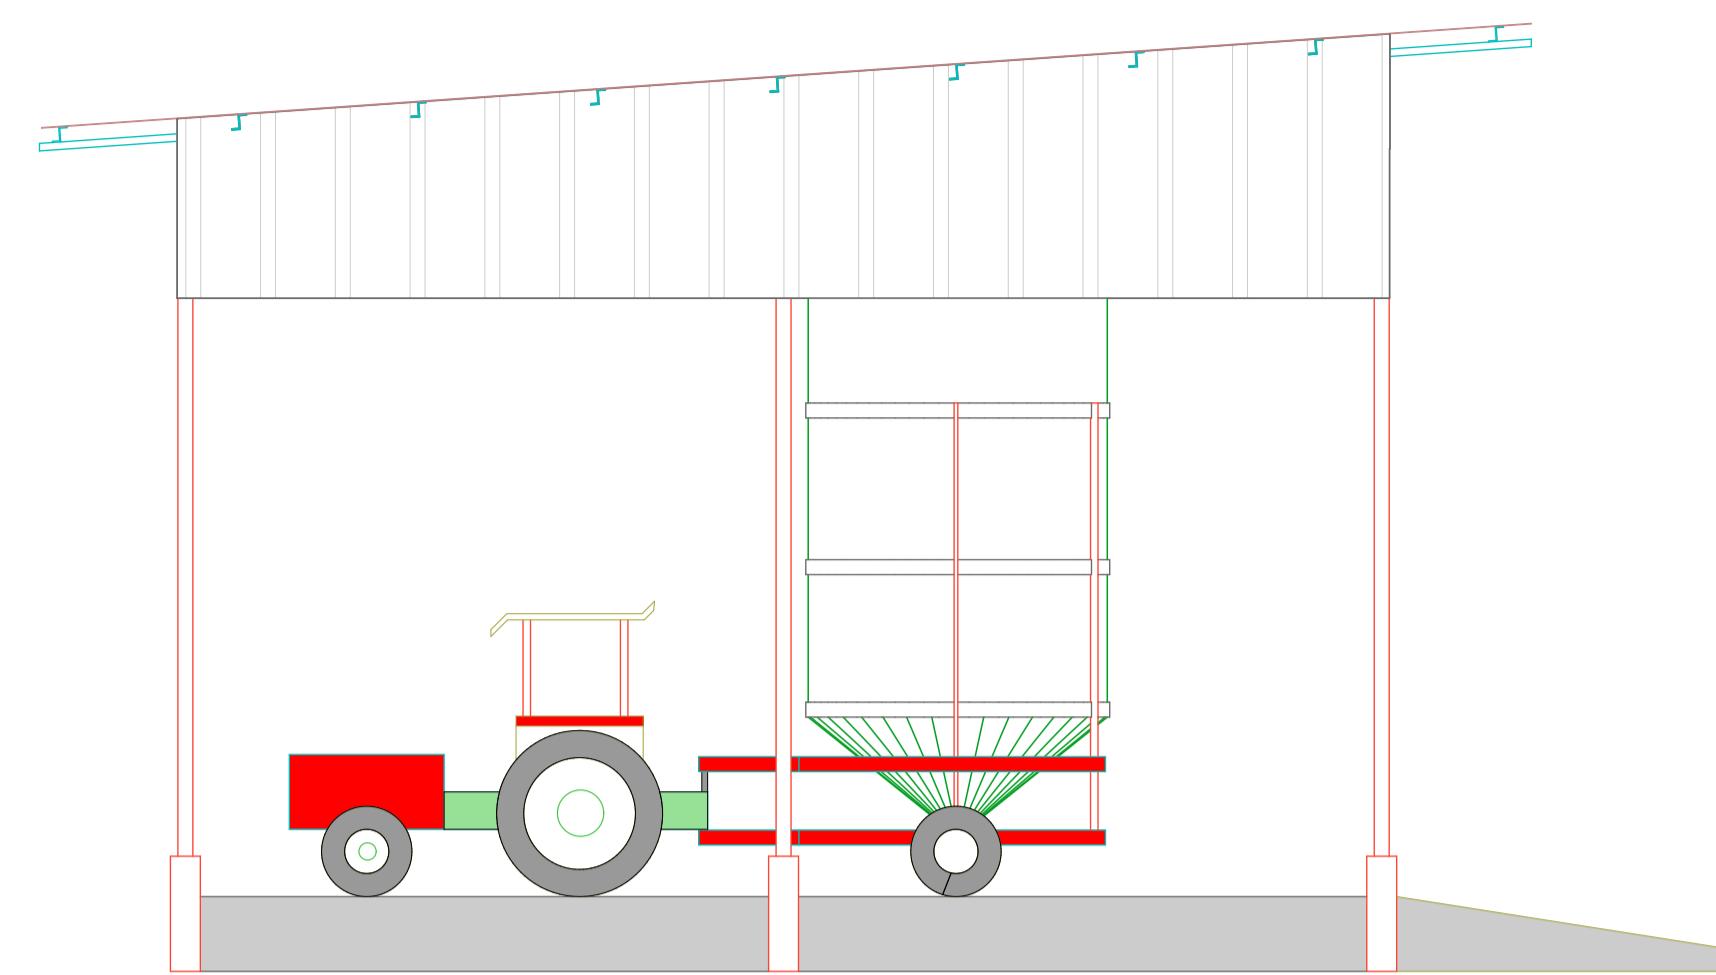


ELEVATION 03

(Scale= 1:50)

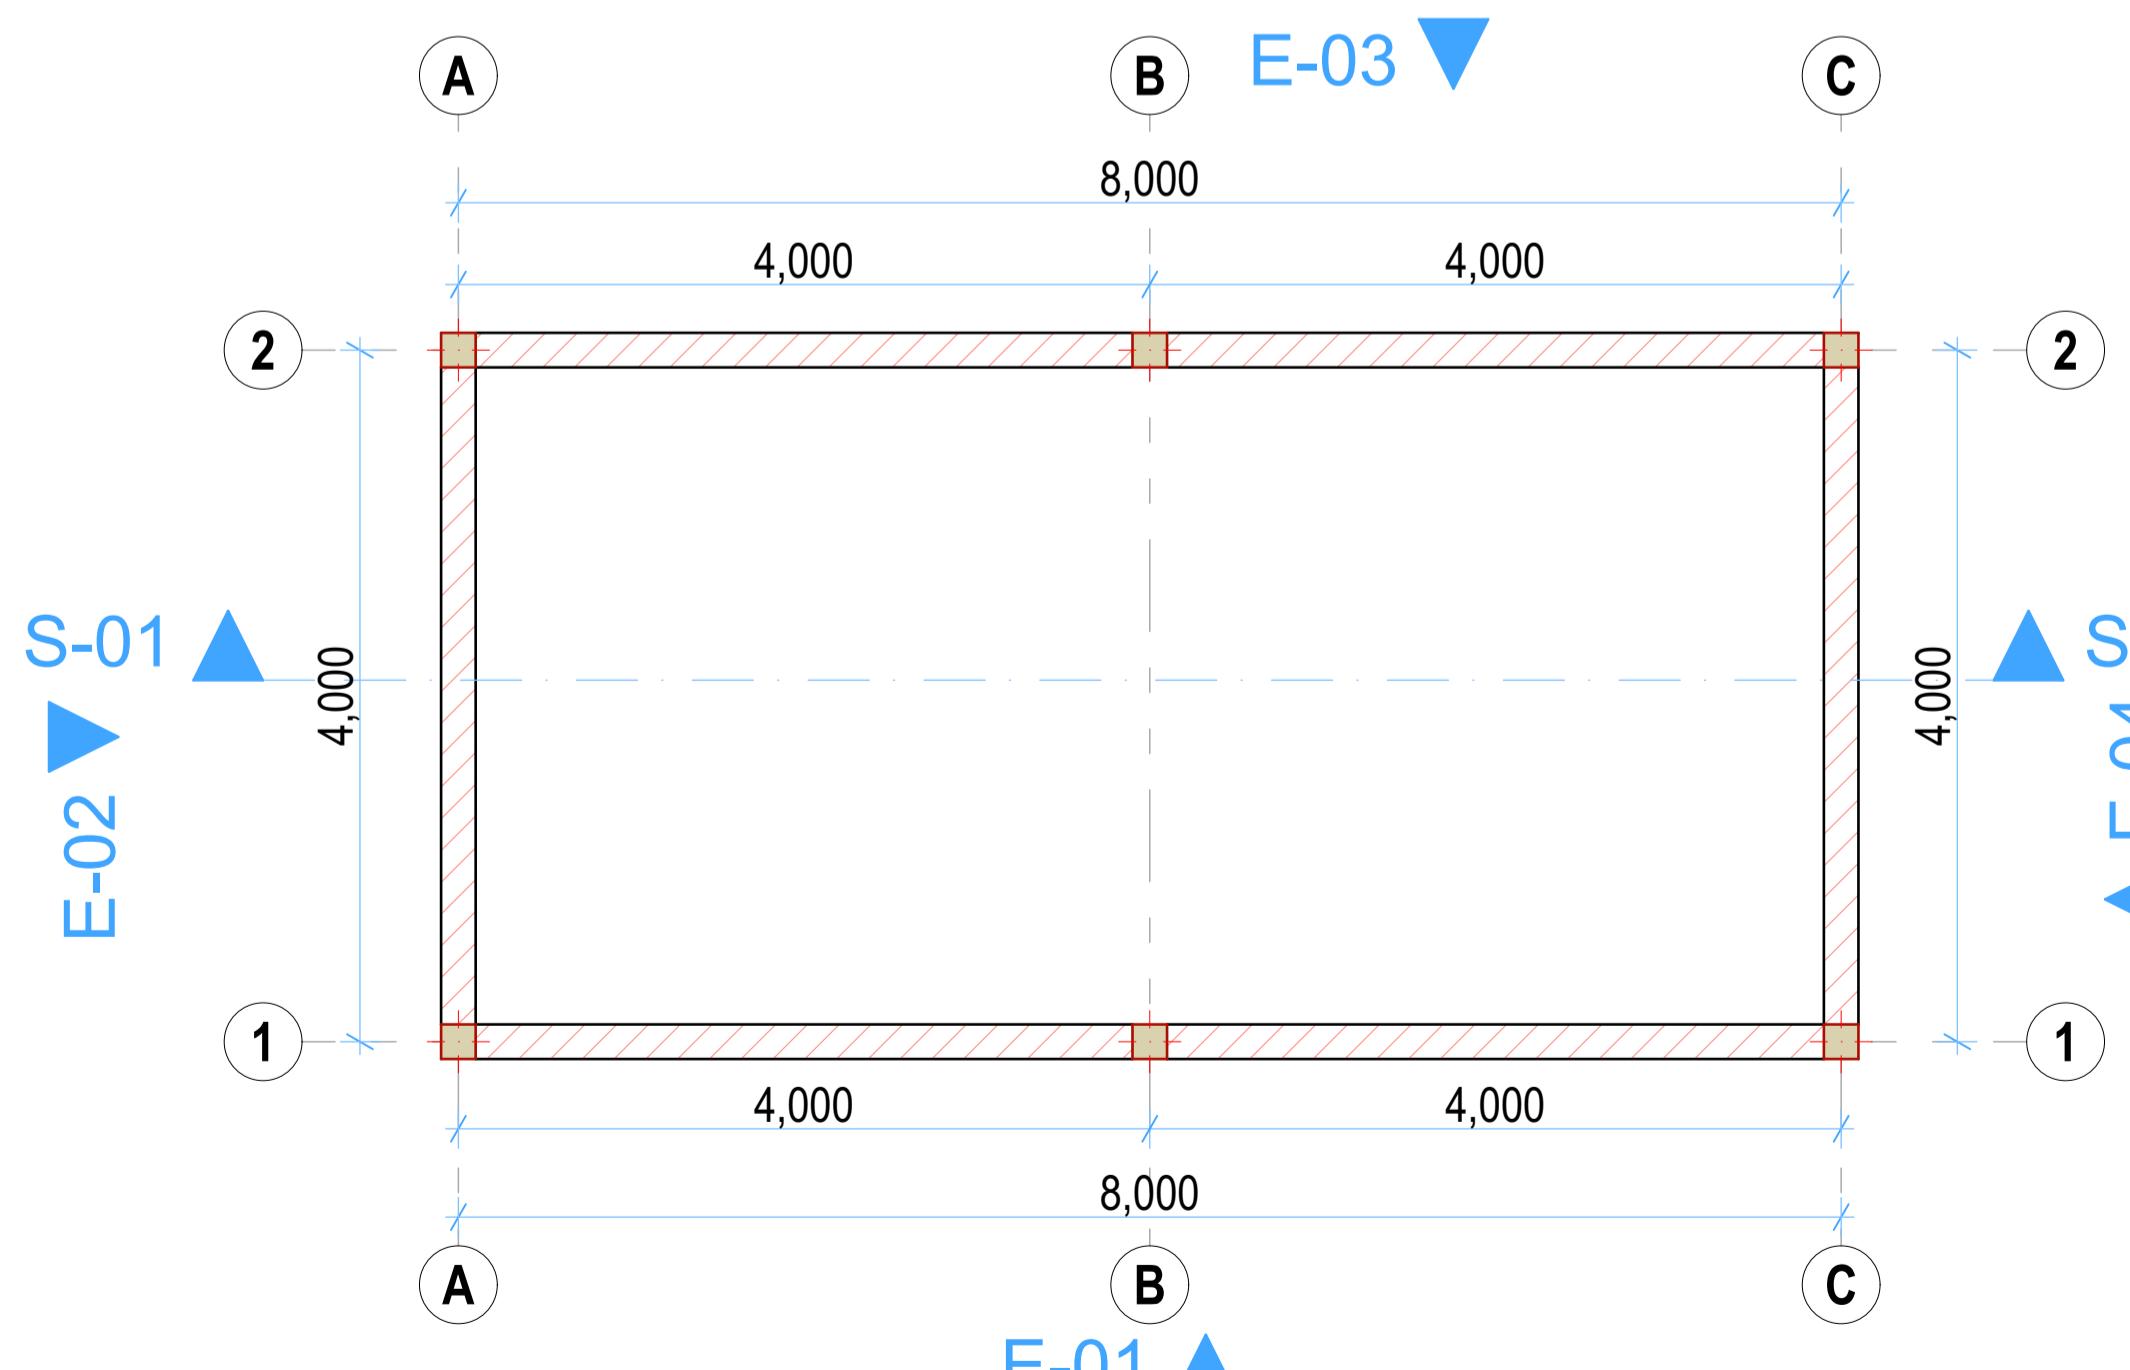

SHED PLAN LAYOUT

(Scale= 1:50)

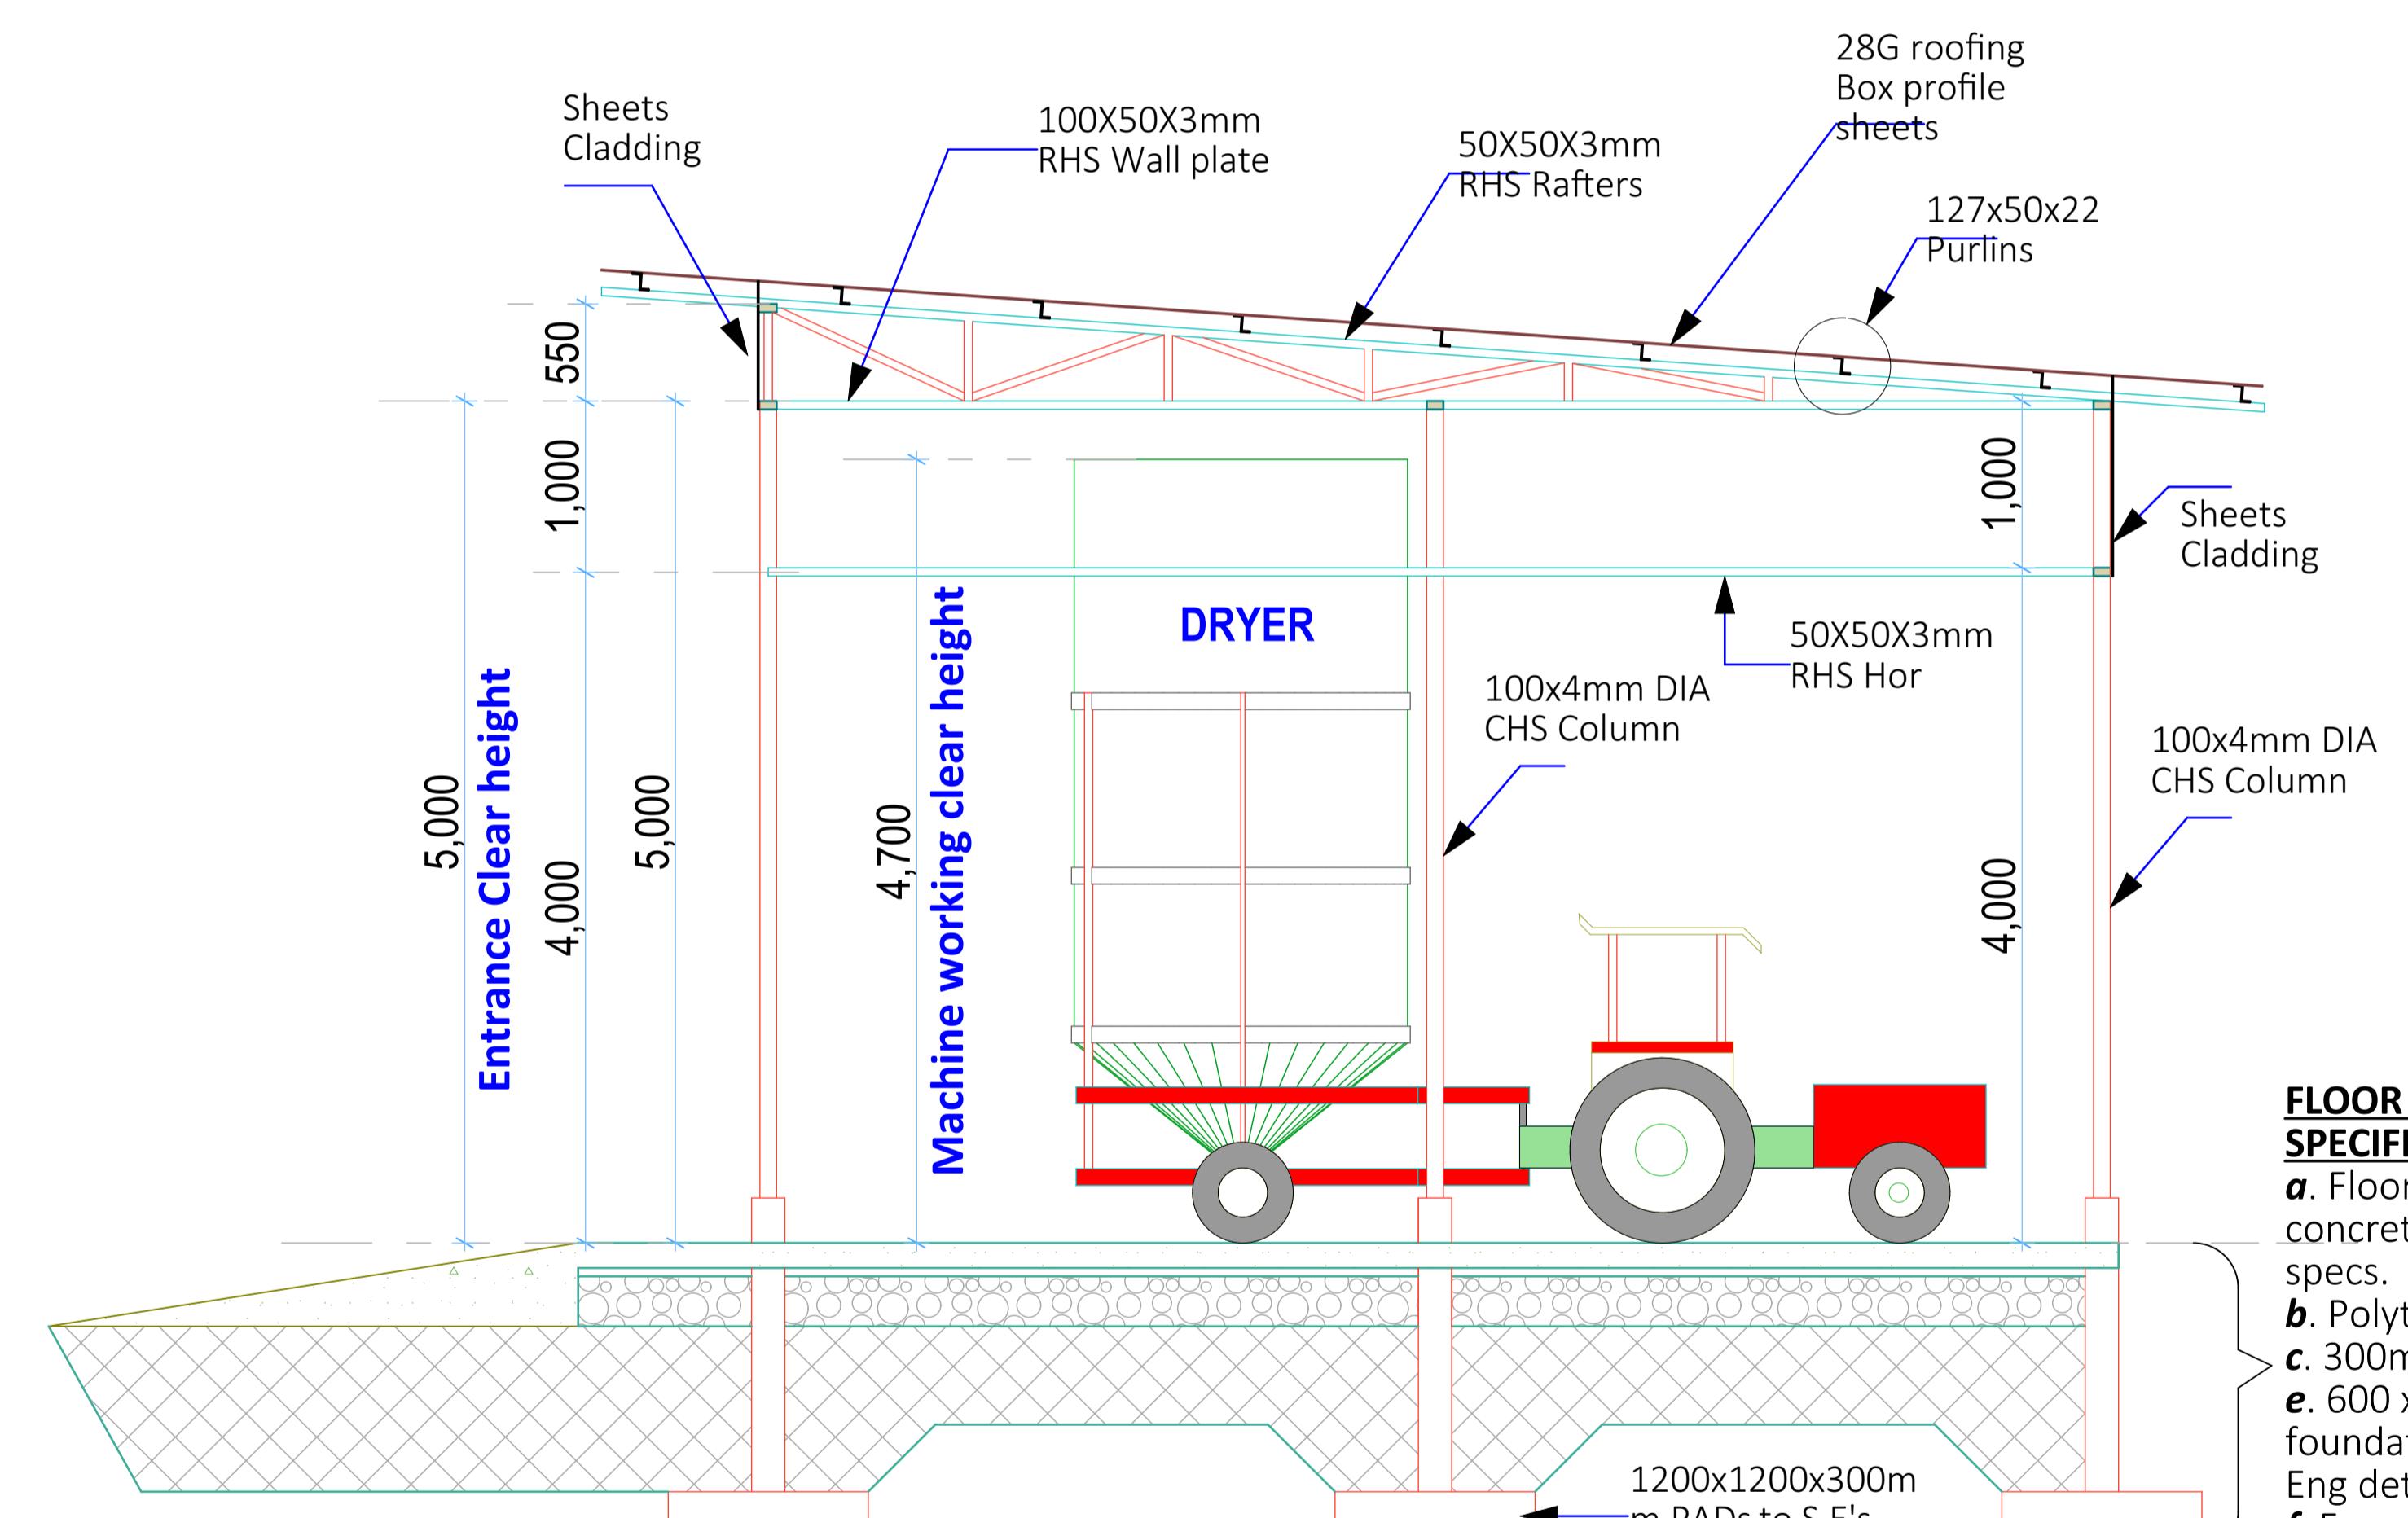


SECTION 01-01

(Scale= 1:50)

FLOOR & FOUNDATION SPECIFICATIONS

- a. Floor finish on 200mm thick concrete floor slab to Str. Eng. specs.
- b. Polythene DPM 1000 Gauge
- c. 300mm Compacted hardcore
- e. 600 x 200mm Strip foundation footing or as per Str. Eng detail
- f. Foundation depth to be determined on site but at least 1500mm deep


REV.	DESCRIPTION:	DATE:	DRAWN BY:	DESIGNED BY:	CLIENT:	PROJECT:
A.	FIRST ISSUE	DEC, 2024	Francis K. Ngigi	1. Eng. Amos Kiptanui	State Department of Agriculture Ministry of Agriculture and Livestock Development, Cathedral Road, Nairobi P. O. Box 30028-00100 Nairobi- Kenya	PROPOSED SIRWA AGGREGATION CENTER IN MOGOTIO CONSTITUENCY, BARINGO COUNTY
				2. Eng. Laban Kiplagat		
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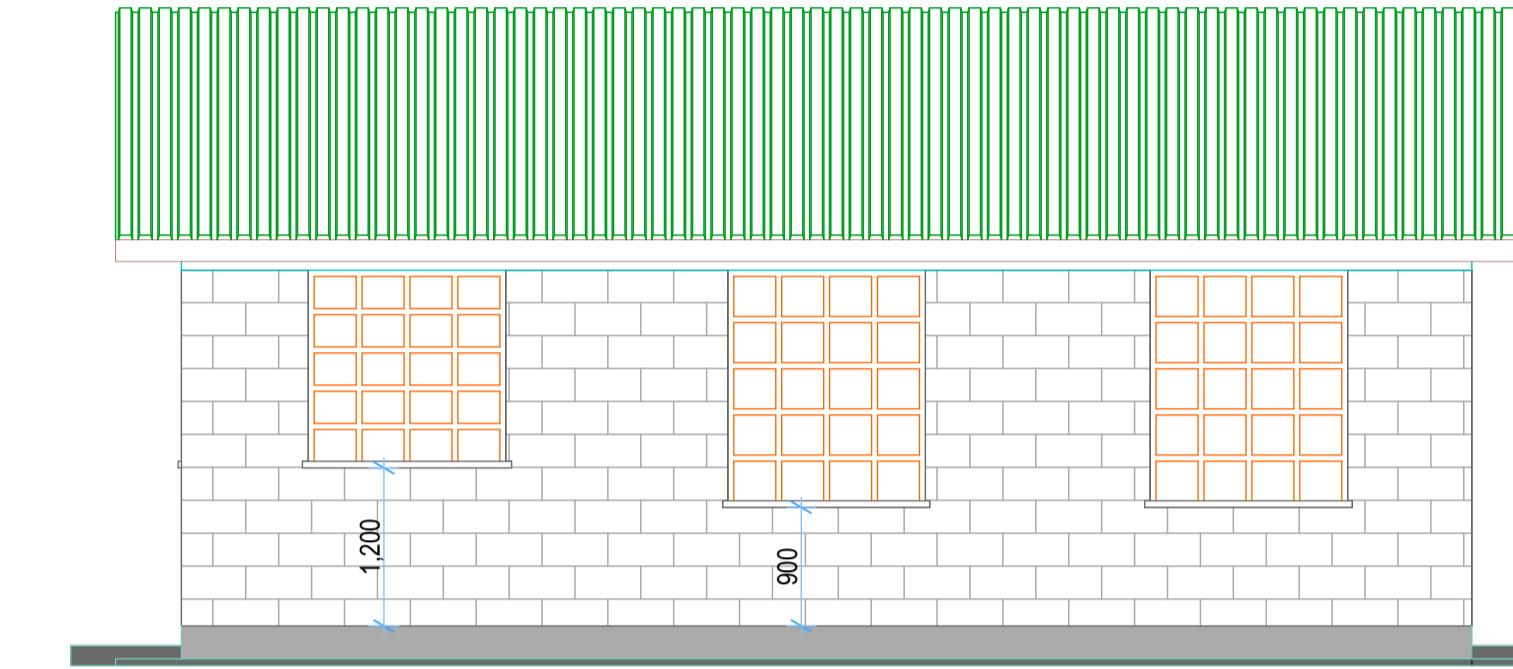
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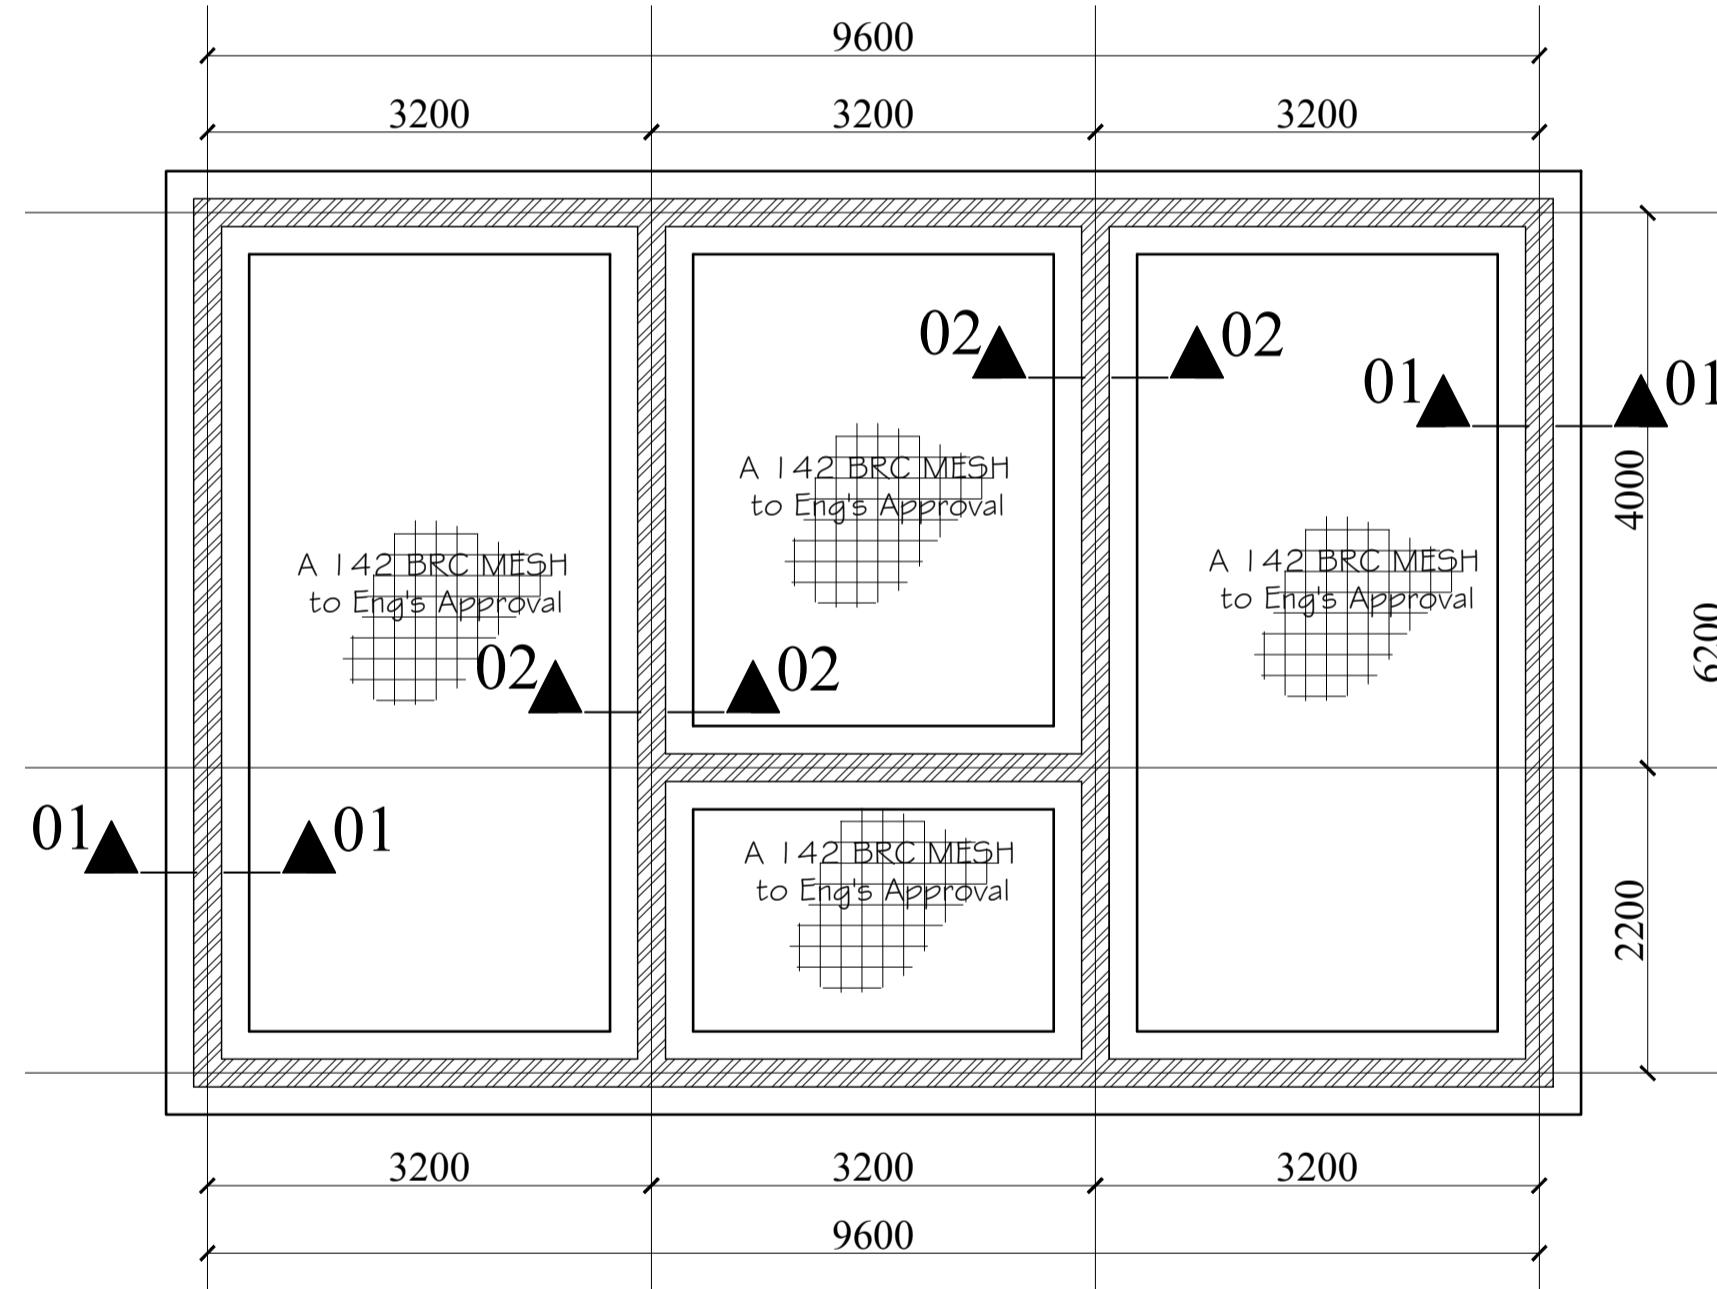
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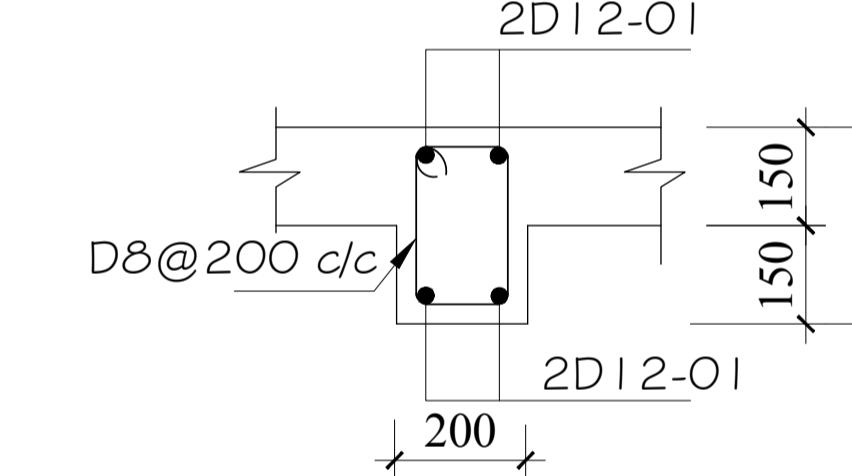
ELEVATION

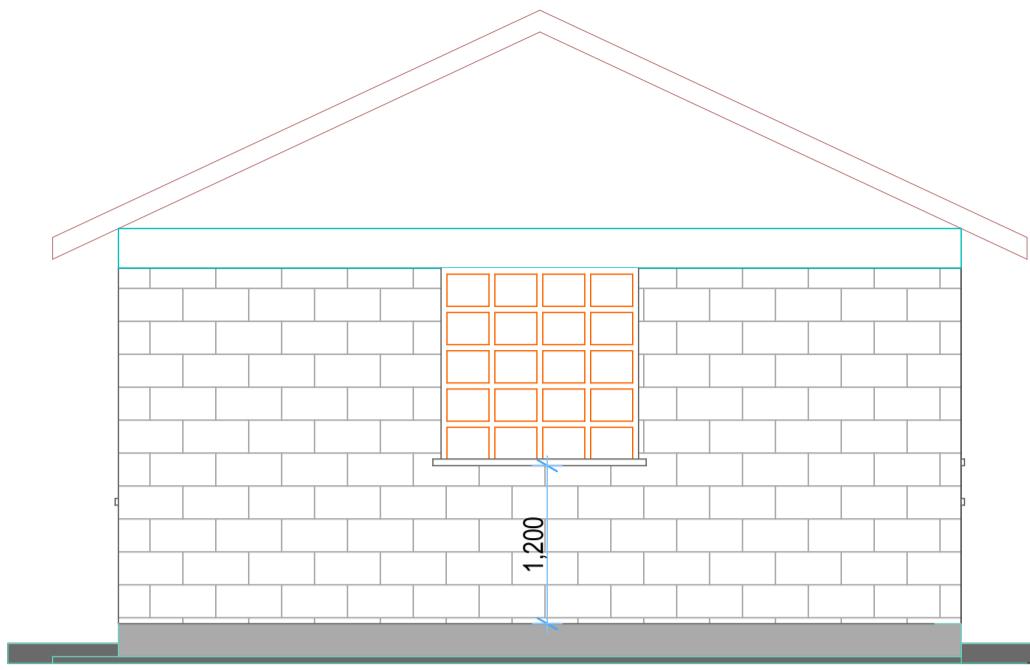

ELEVATION (Scale= 1:500)




FOUNDATION PLAN LAYOUT, (1:10)

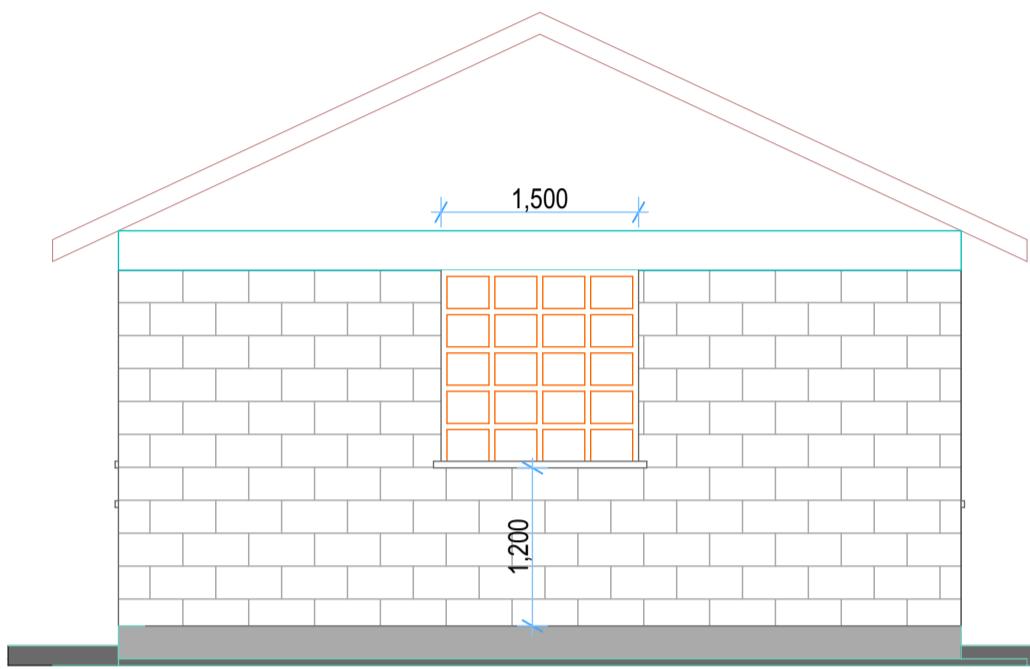


Ring Beam Bear

Section through Ring beam


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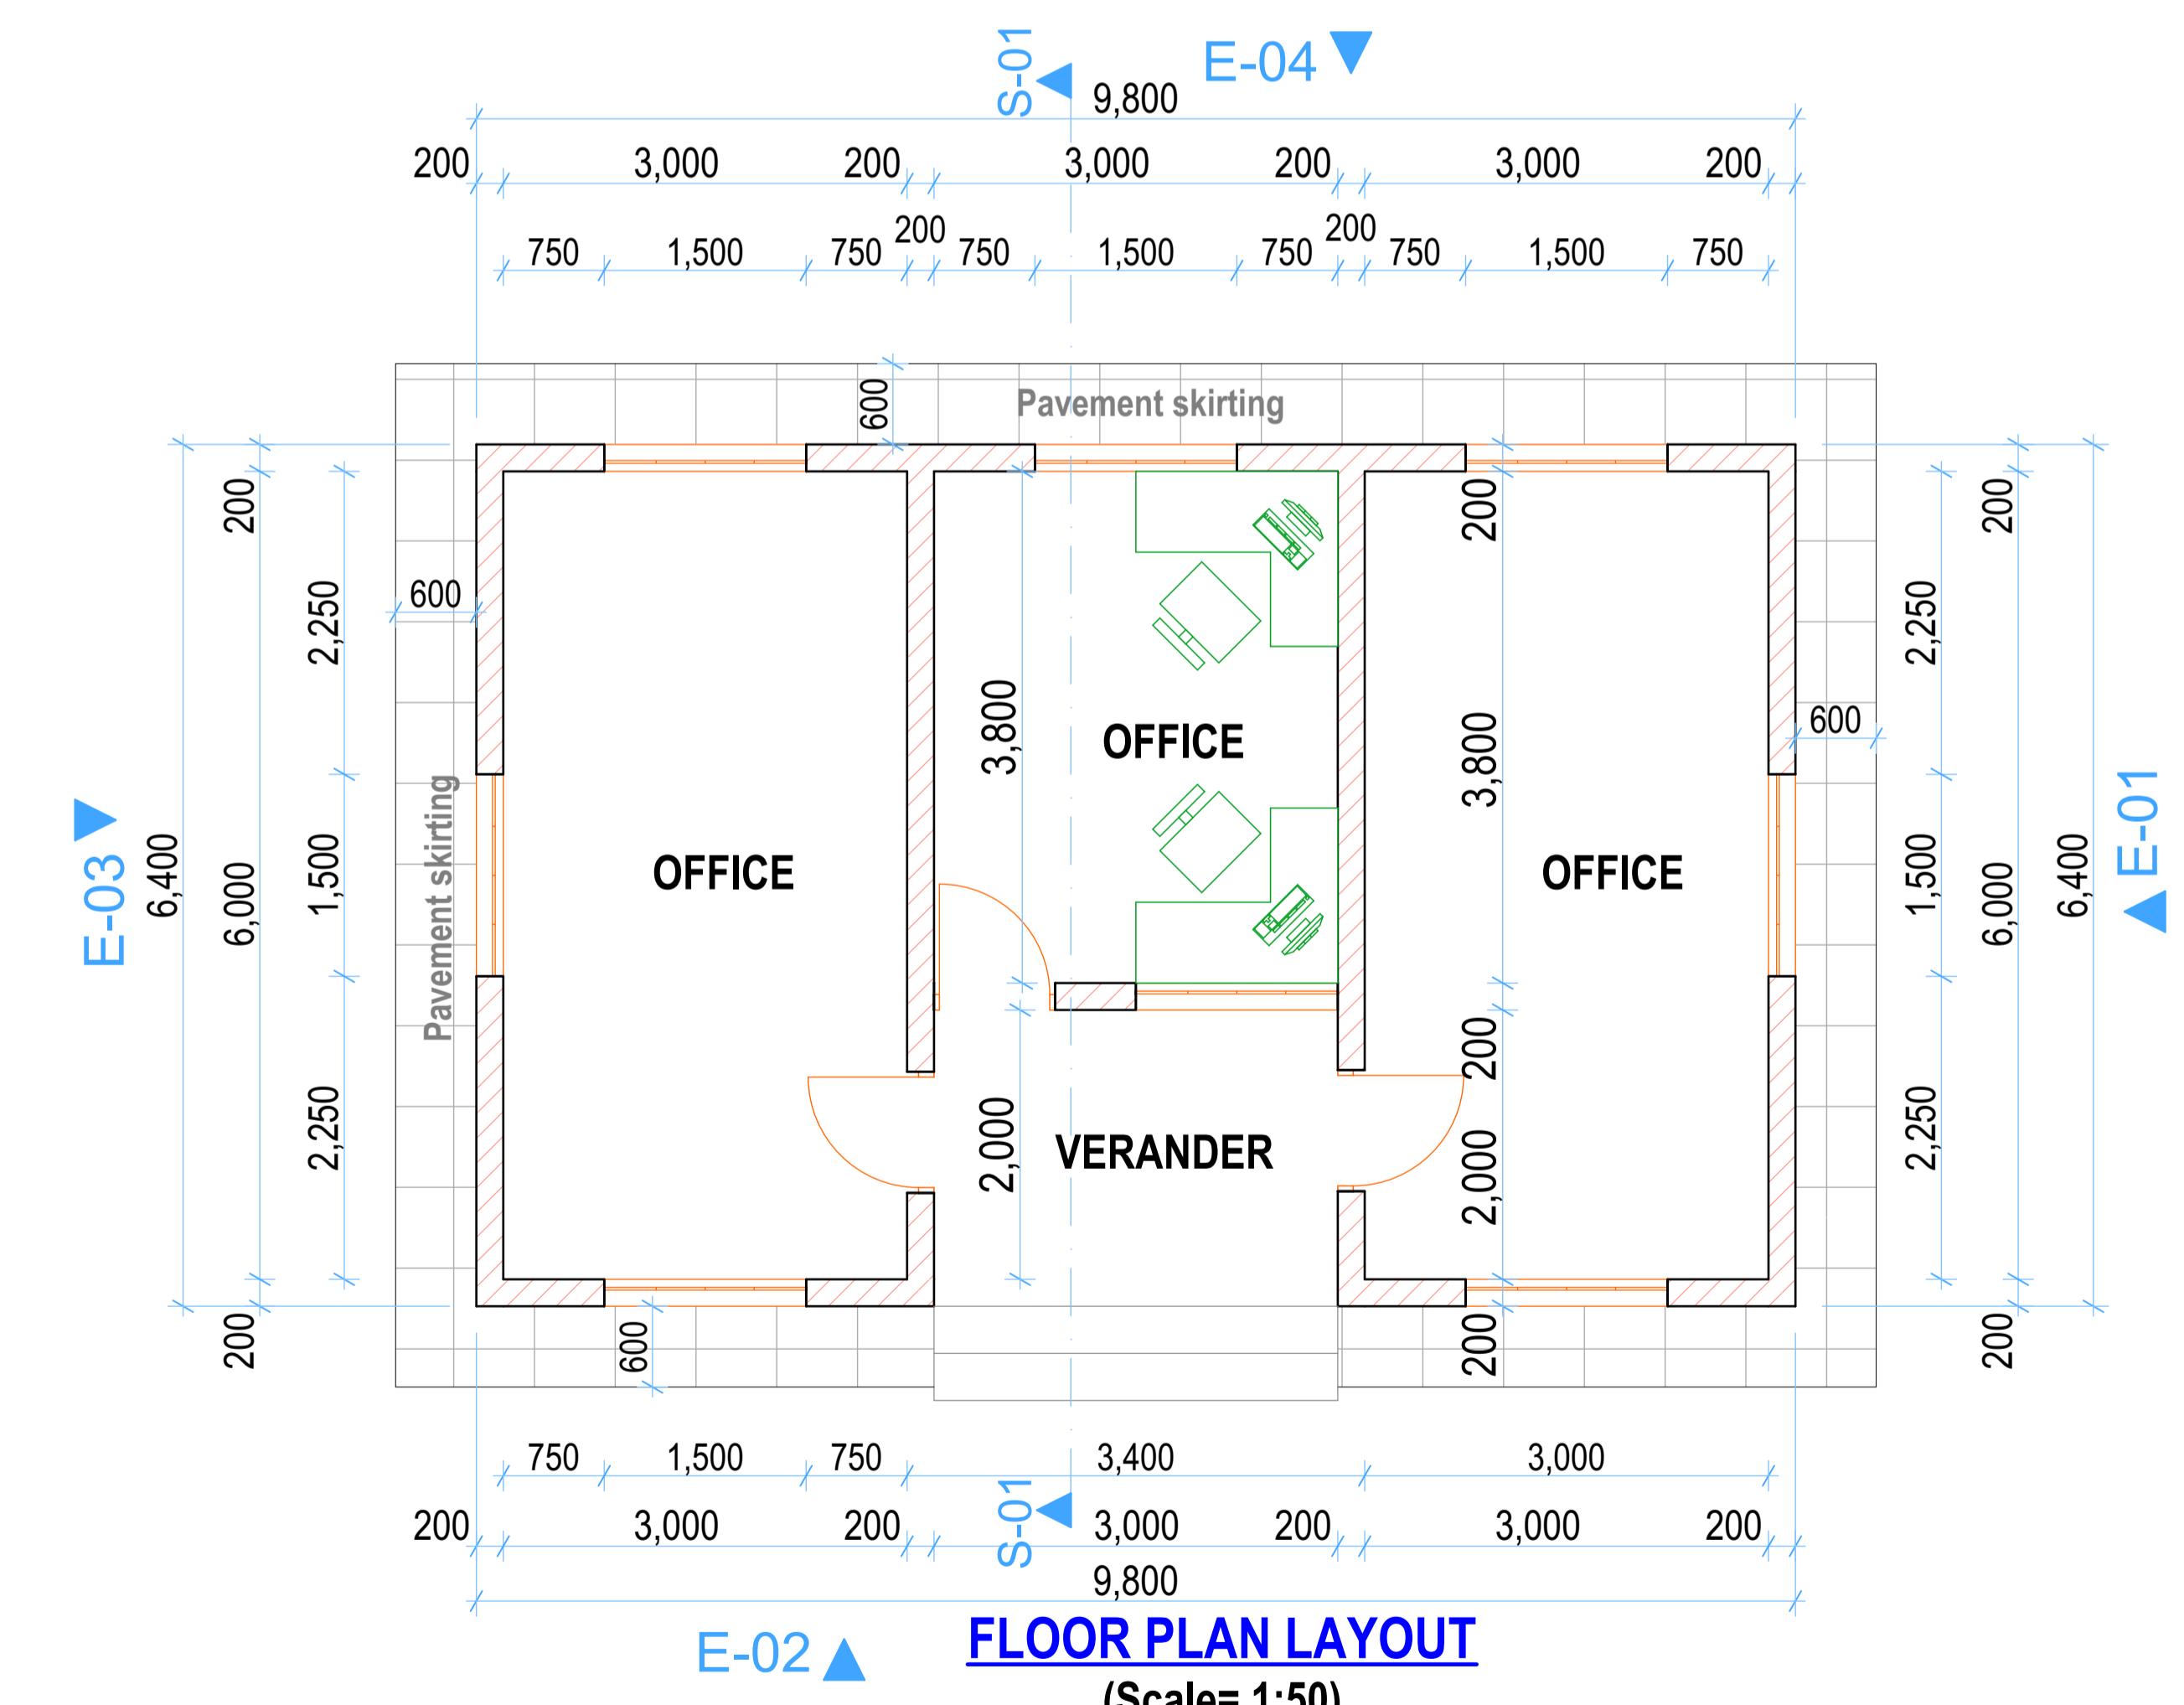
**STRIP FOUNDATION
SECTION 02-02 (1:50)**

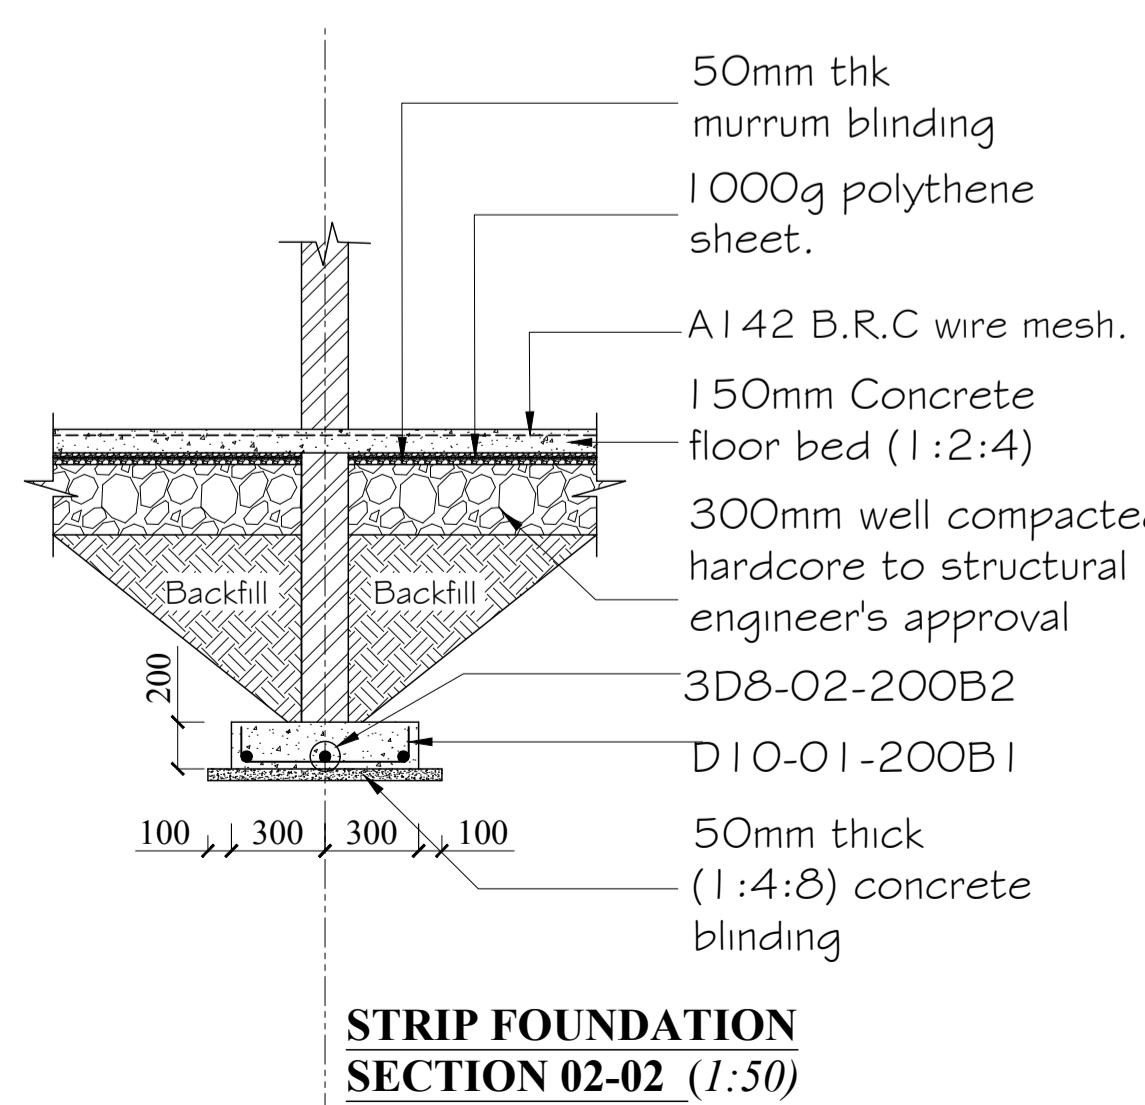

STRIP FOUND
SECTION 01-01

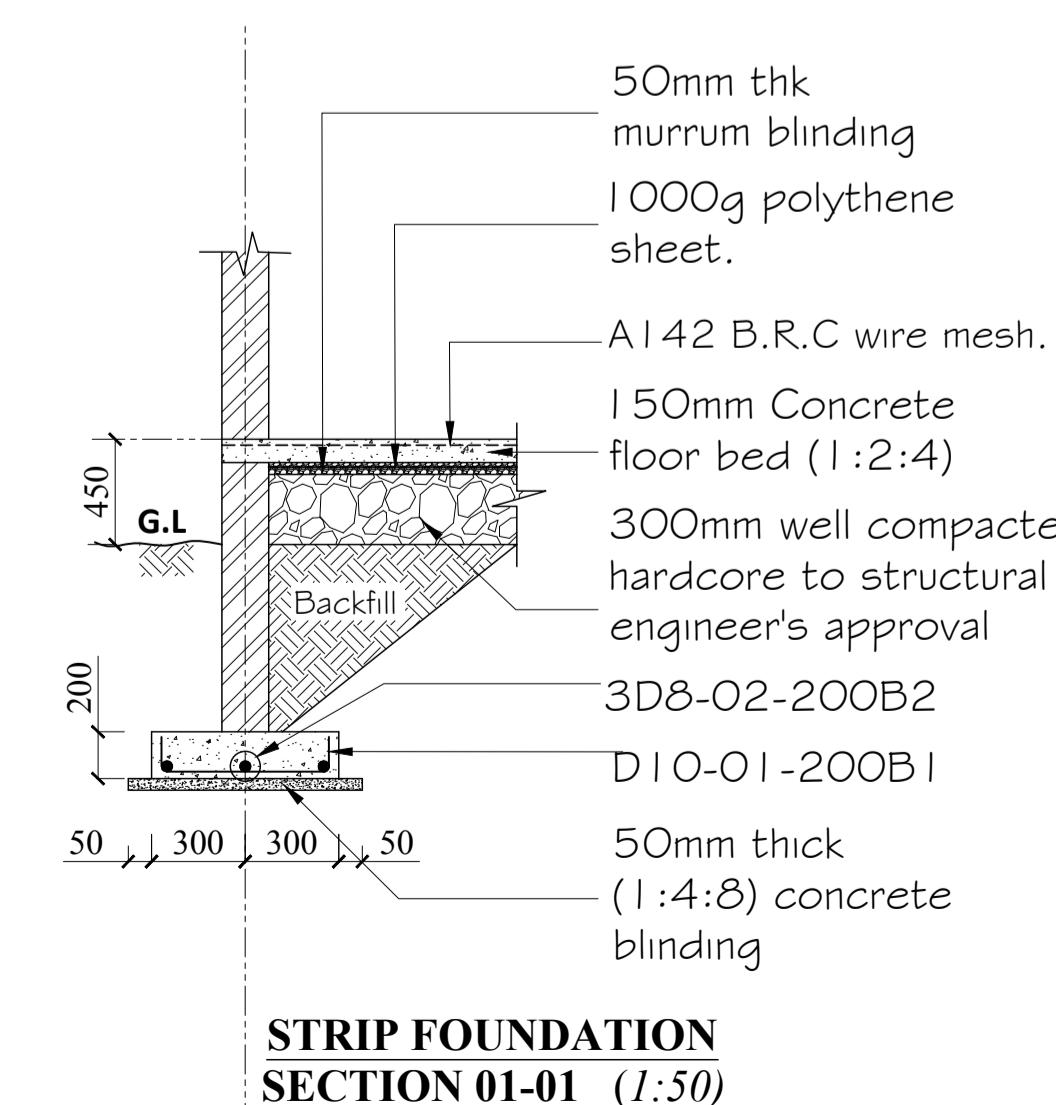


SECTION 01-01

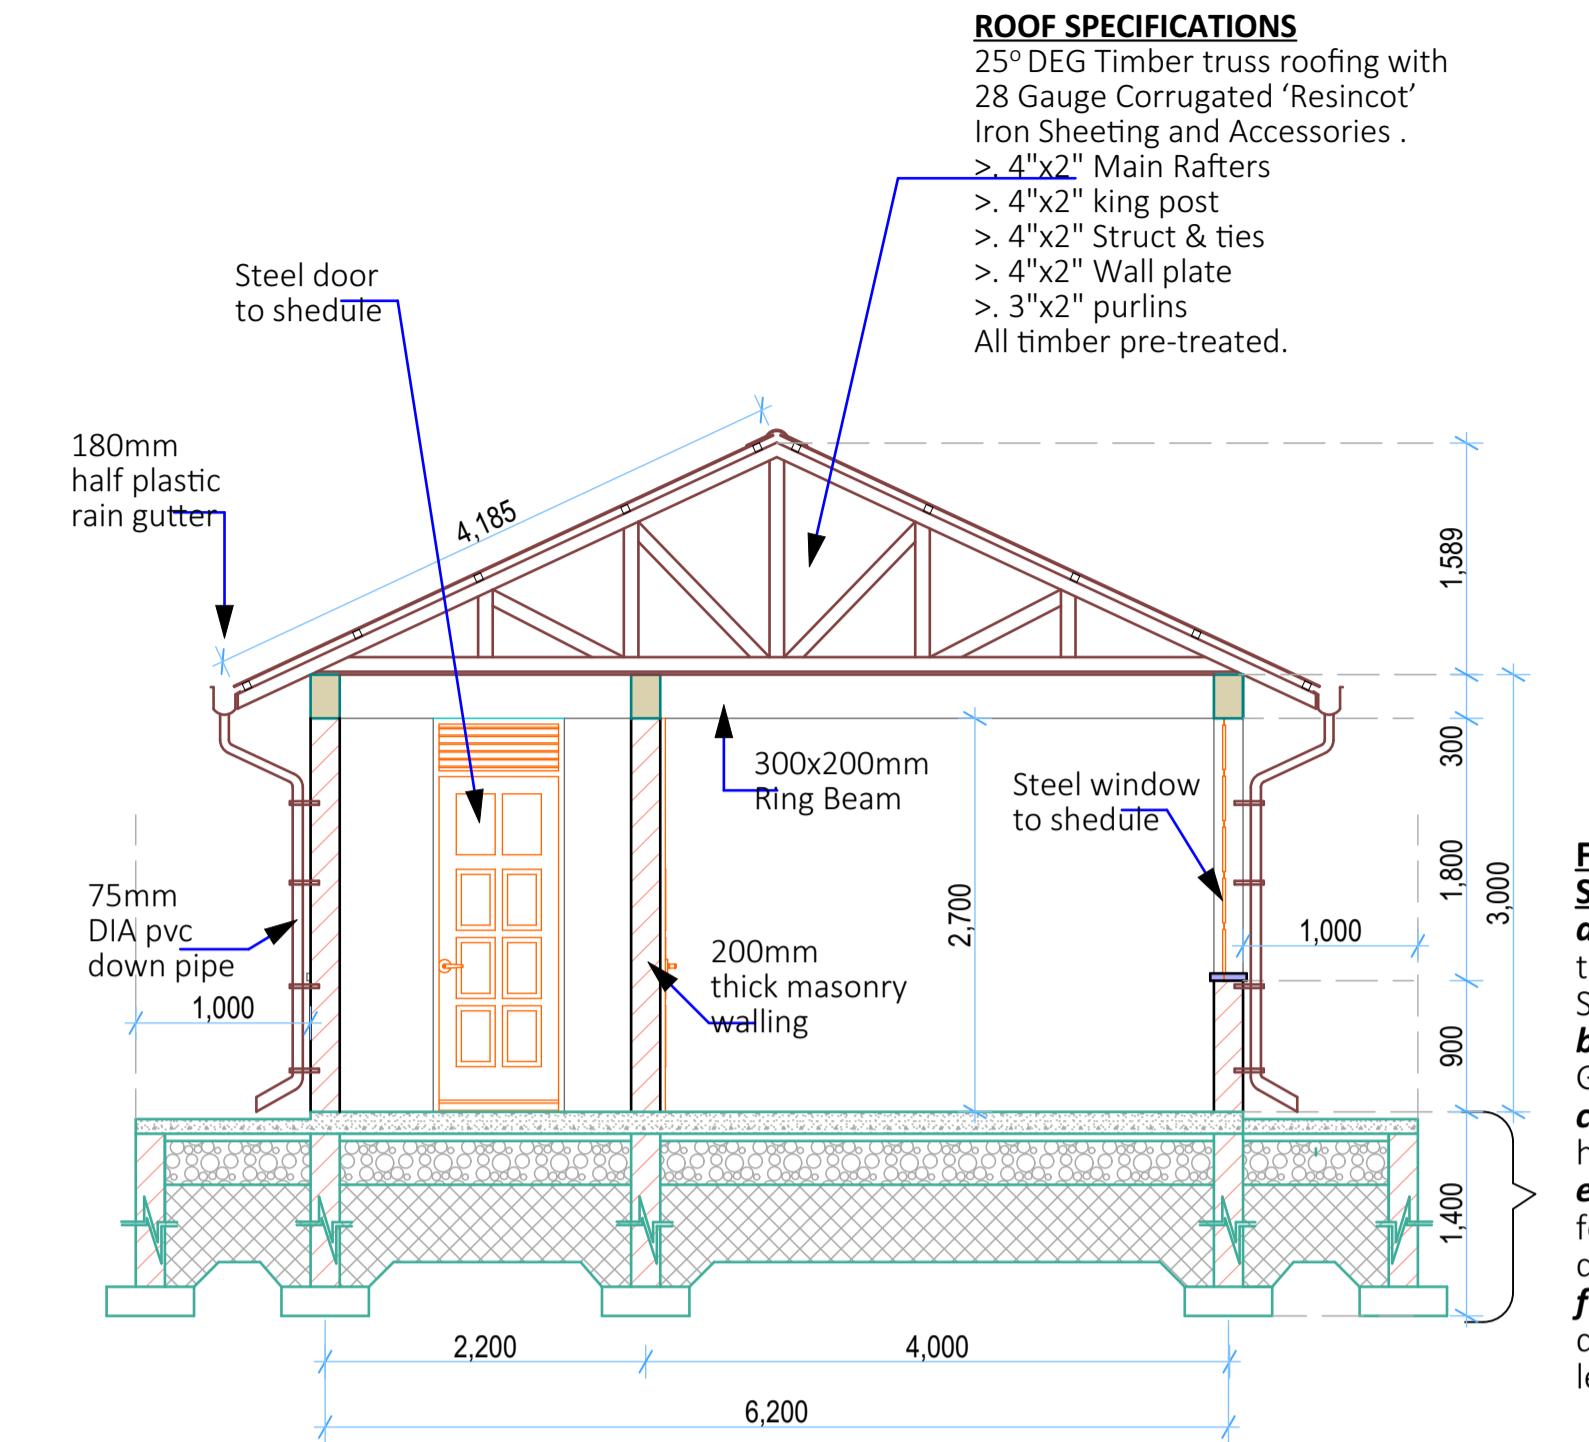


FLOOR PLAN LAYOUT

(Scale= 1:50)


REV.	DESCRIPTION:	DATE:	DRAWN BY:	DESIGNED BY:	CLIENT:	PROJECT: PROPOSED SIRWA AGGREGATION CENTER IN MOGOTIO CONSTITUENCY, BARINGO COUNTY
A.	FIRST ISSUE	DEC, 2024	Francis K. Ngigi	1. Eng. Amos Kiptanui	<p>State Department of Agriculture Ministry of Agriculture and Livestock Development, Cathedral Road, Nairobi P. O. Box 30028-00100 Nairobi- Kenya</p> 	<p>TITLE: (OFFICE) Floor Plan Layout, Sections, Elevations and foundation details</p>
				CHECKED BY:		<p>DRG NO: MoALD/SIR/005</p>
				1. Eng. Laban Kiplagat		<p>SCALE: As Shown</p>
						<p>Contract NO:</p>
						<p>Sheet: A Sheet</p>

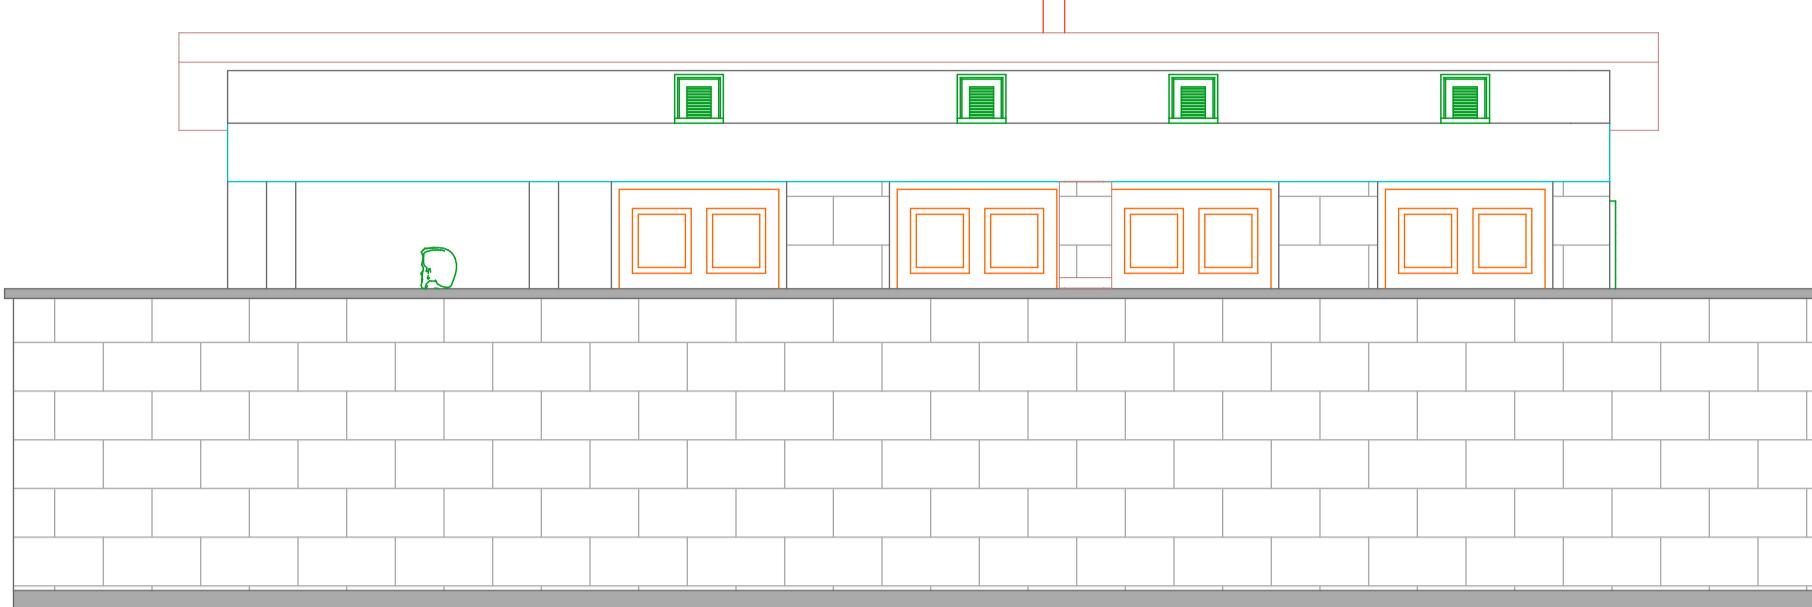


ELEVATION 01
(Scale= 1:50)

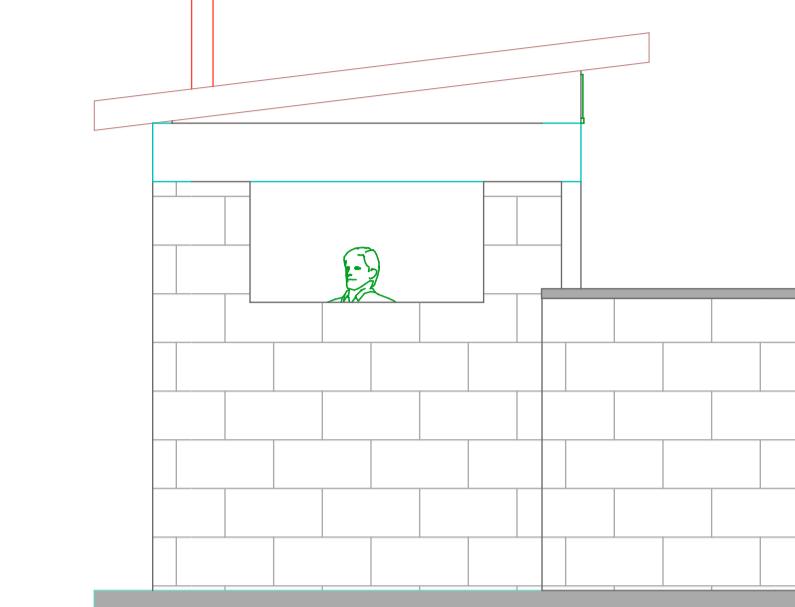


ELEVATION 03
(Scale= 1:50)

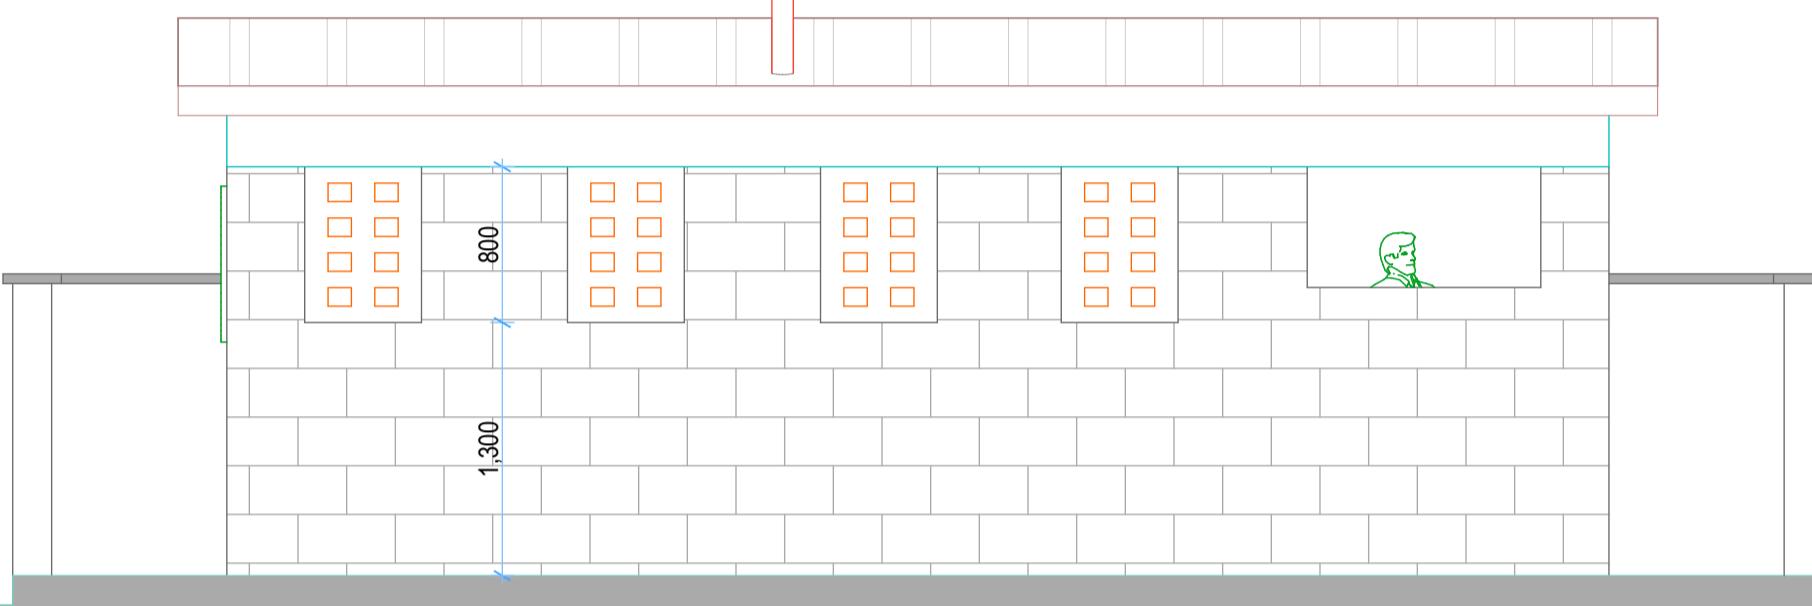

ELEVATION 04
(Scale= 1:50)

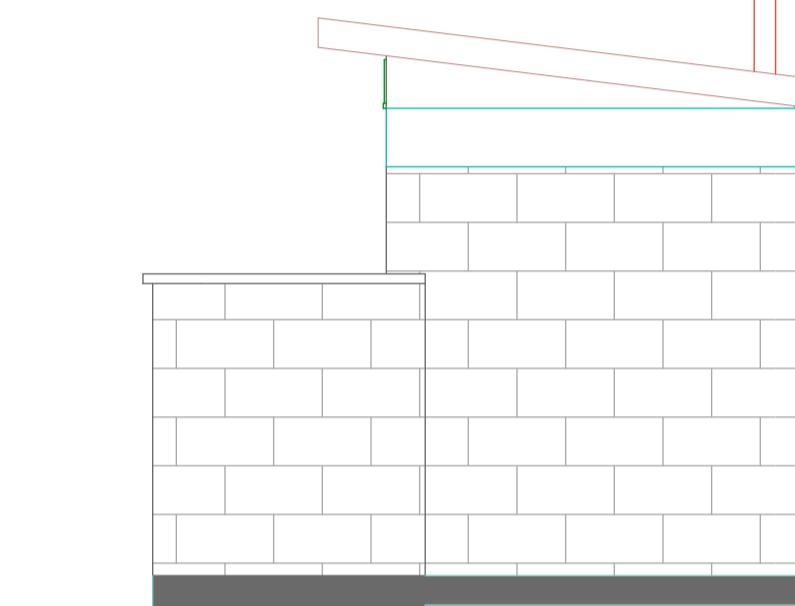


ELEVATION 05
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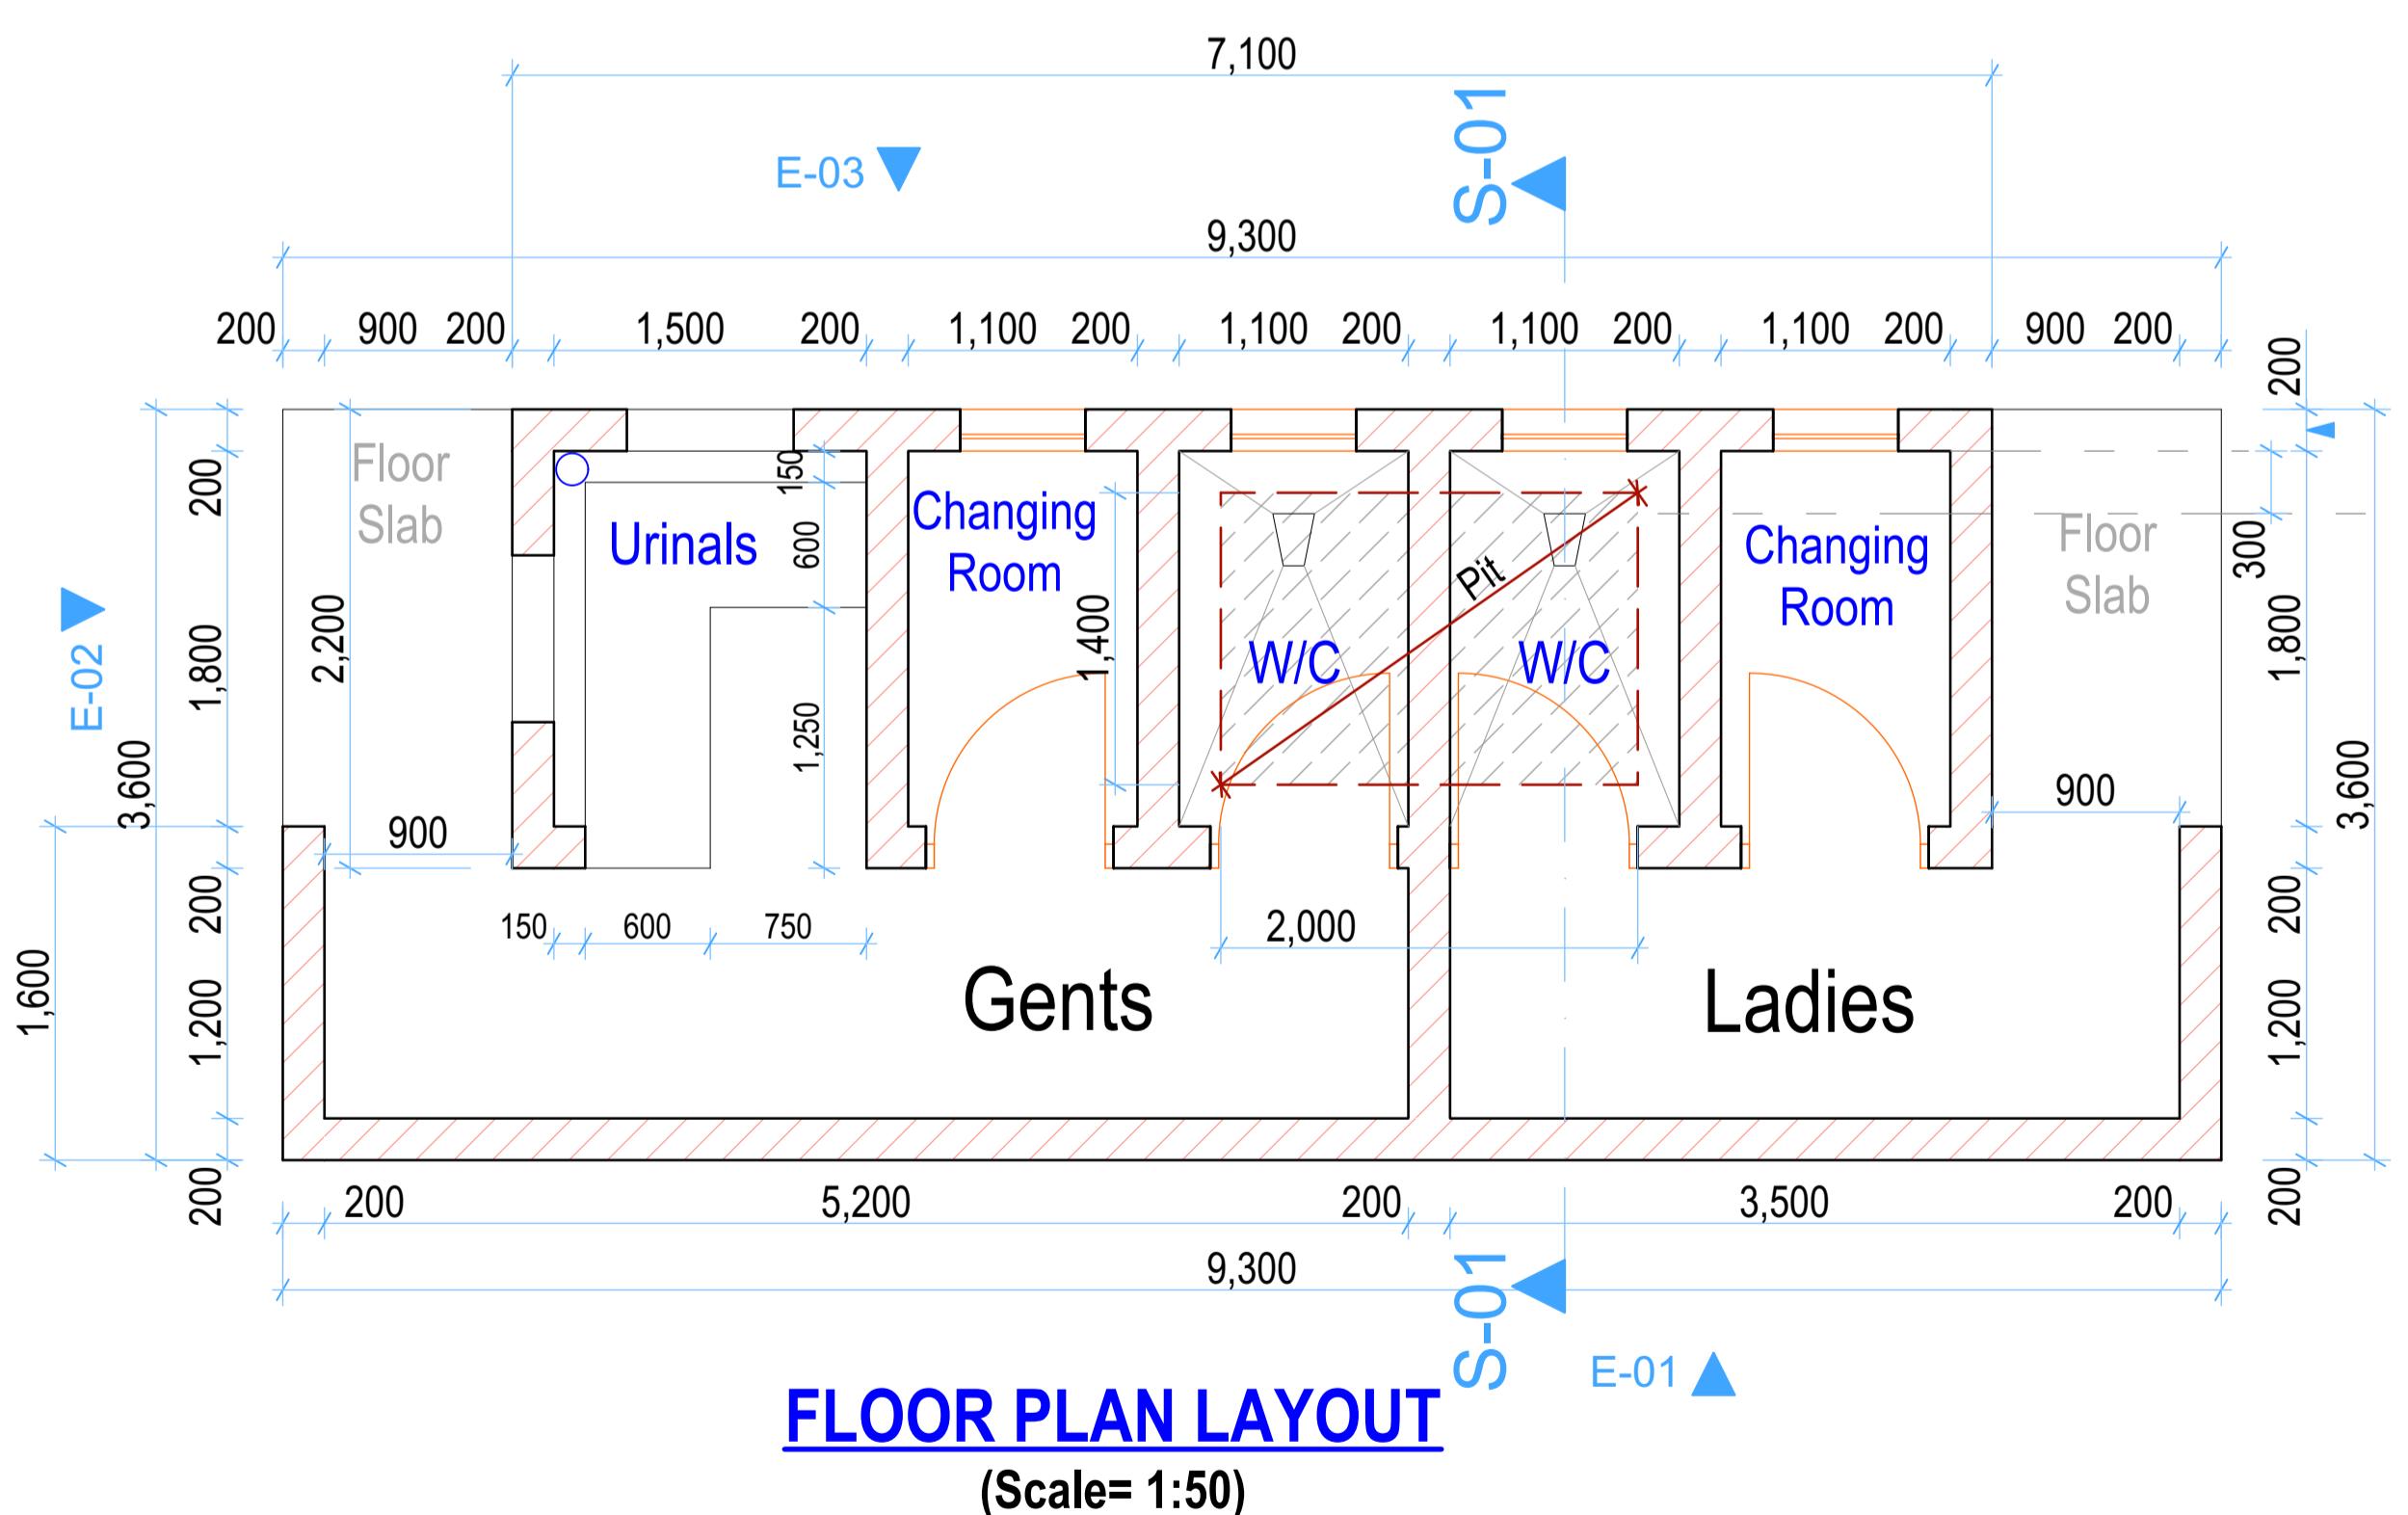


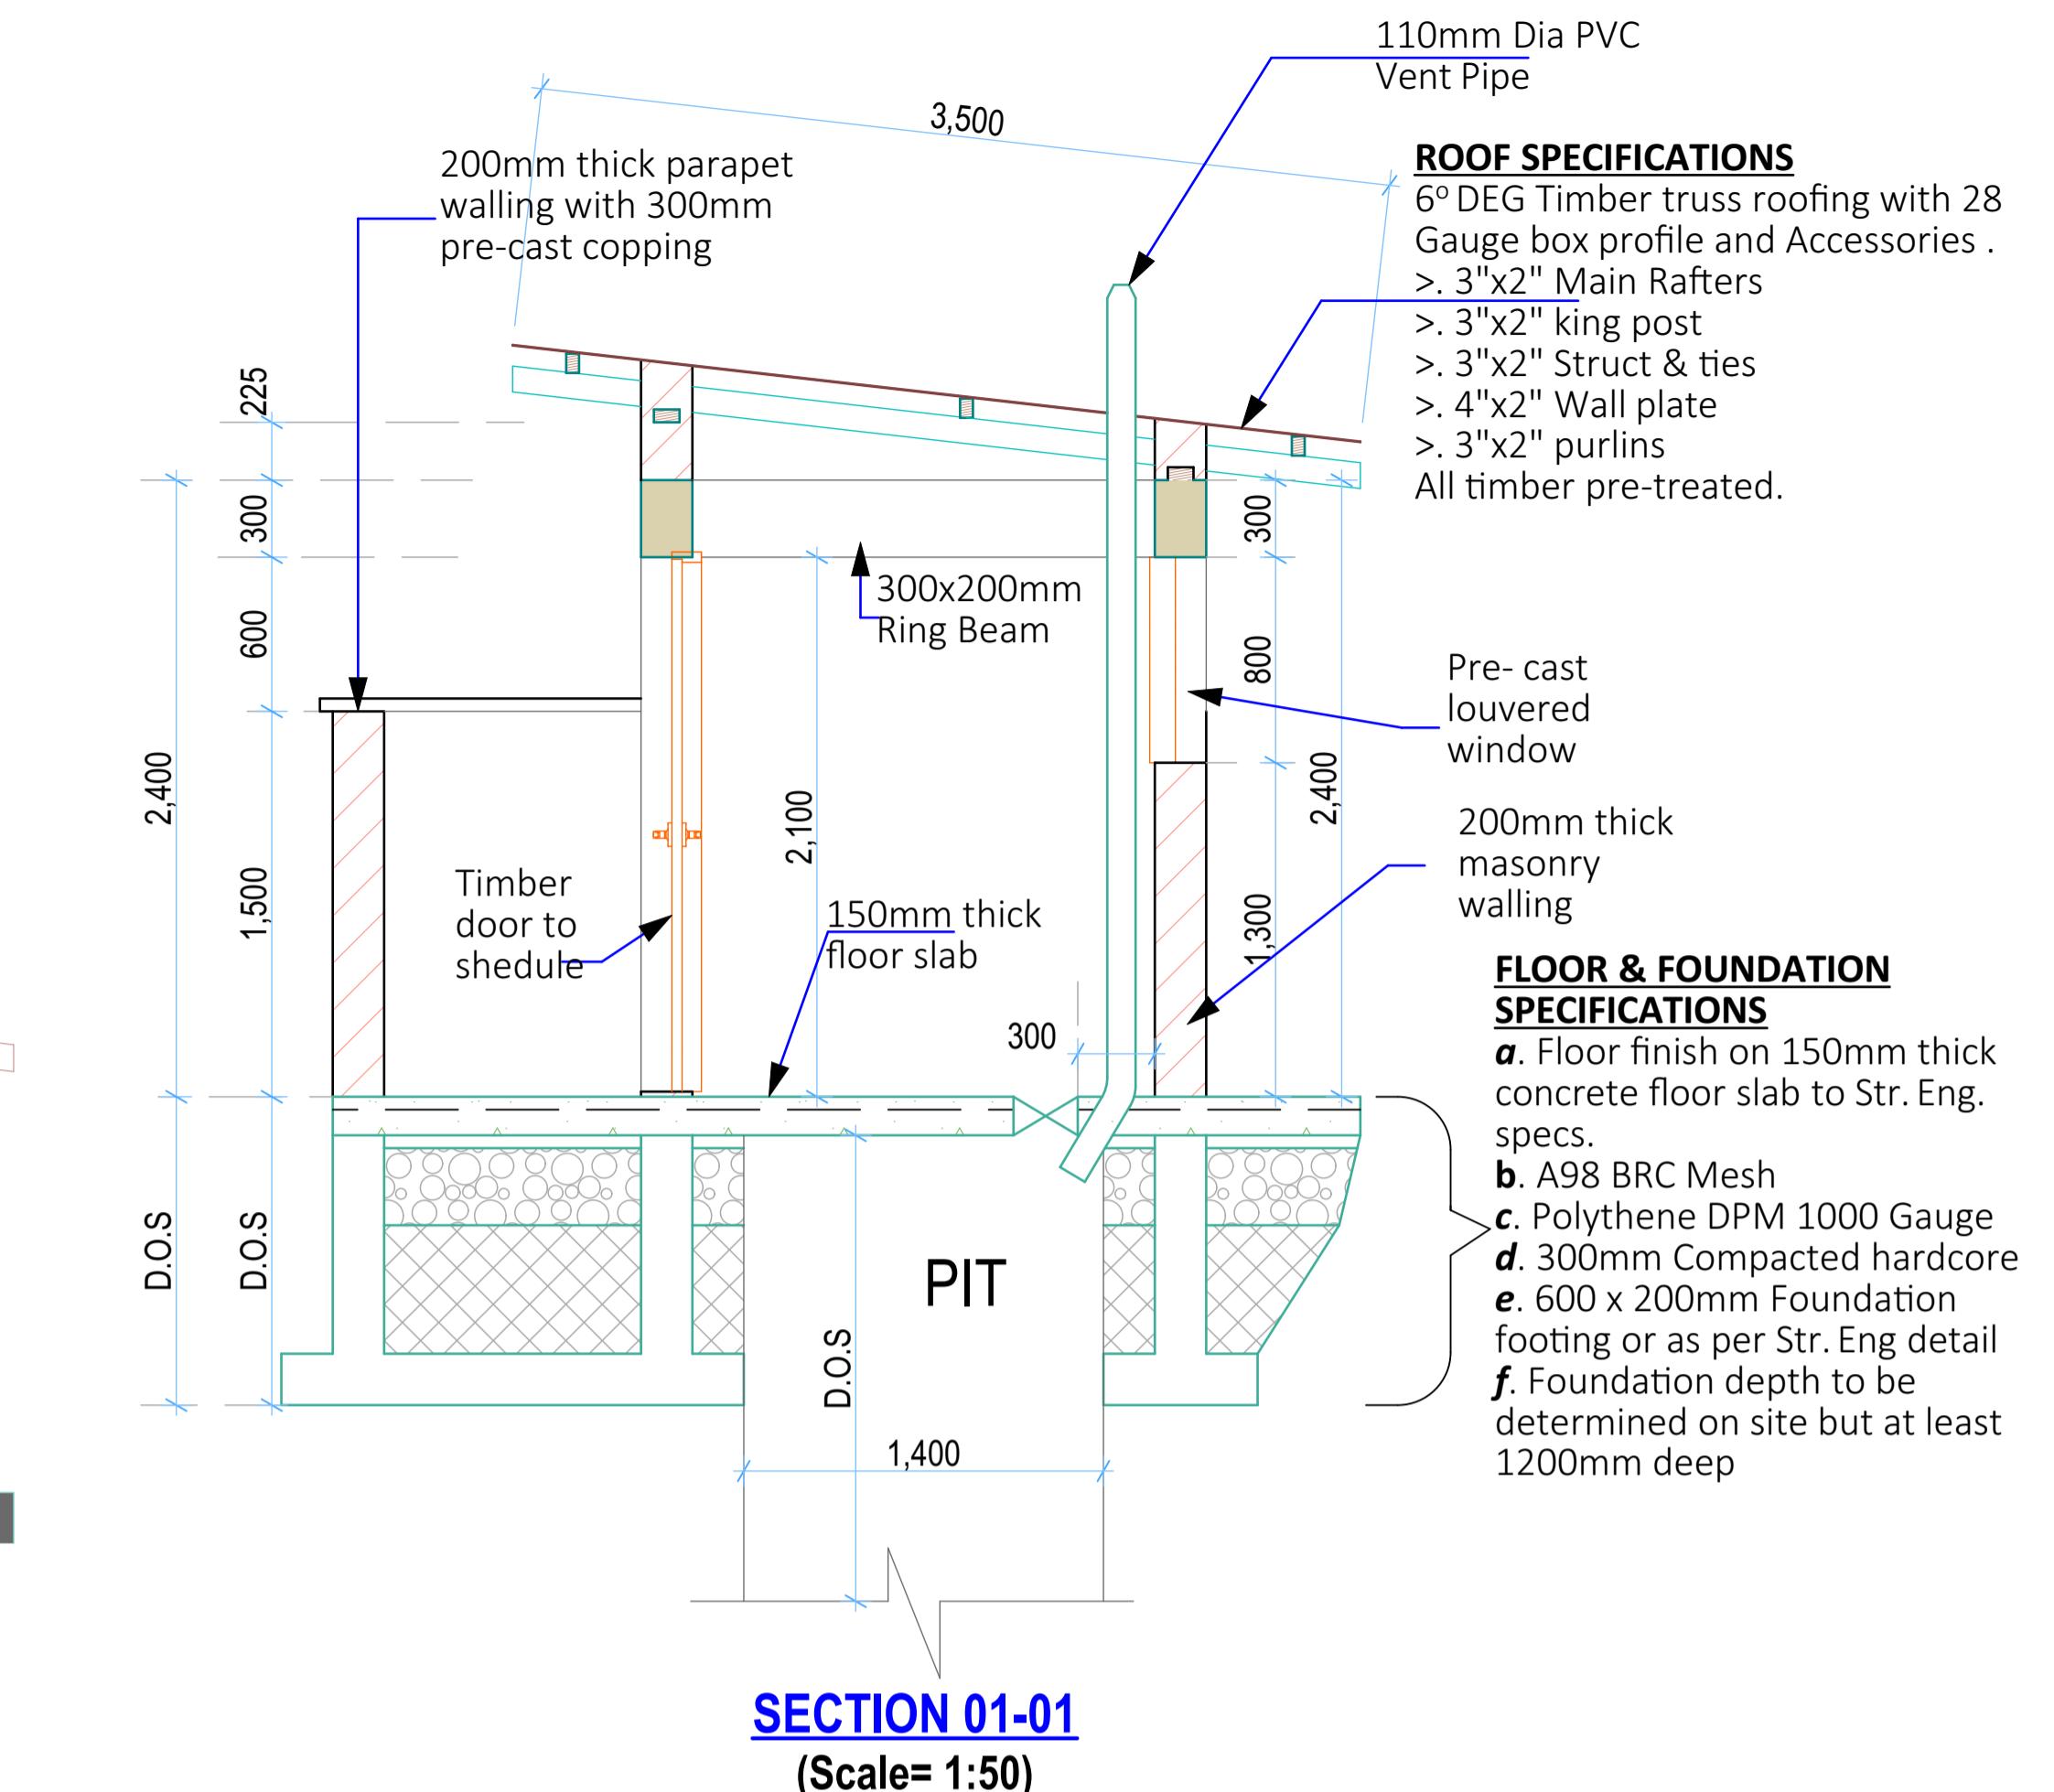SECTION 01-01
(Scale= 1:50)


GENERAL NOTES	
1.	All dimensions to be checked on site. Written dimension rules over scaled dimensions. Any discrepancy in dimensions to be reported to Architect before any work commences.
2.	All construction works to comply with the latest K.B.S. standard codes of practice.
3.	All R.C works are to Structural Engineer's details. Depth of foundation to be determined on site, but should not be less than 700mm.
4.	Plinth level to be minimum 300mm from proposed parking level or existing ground level.
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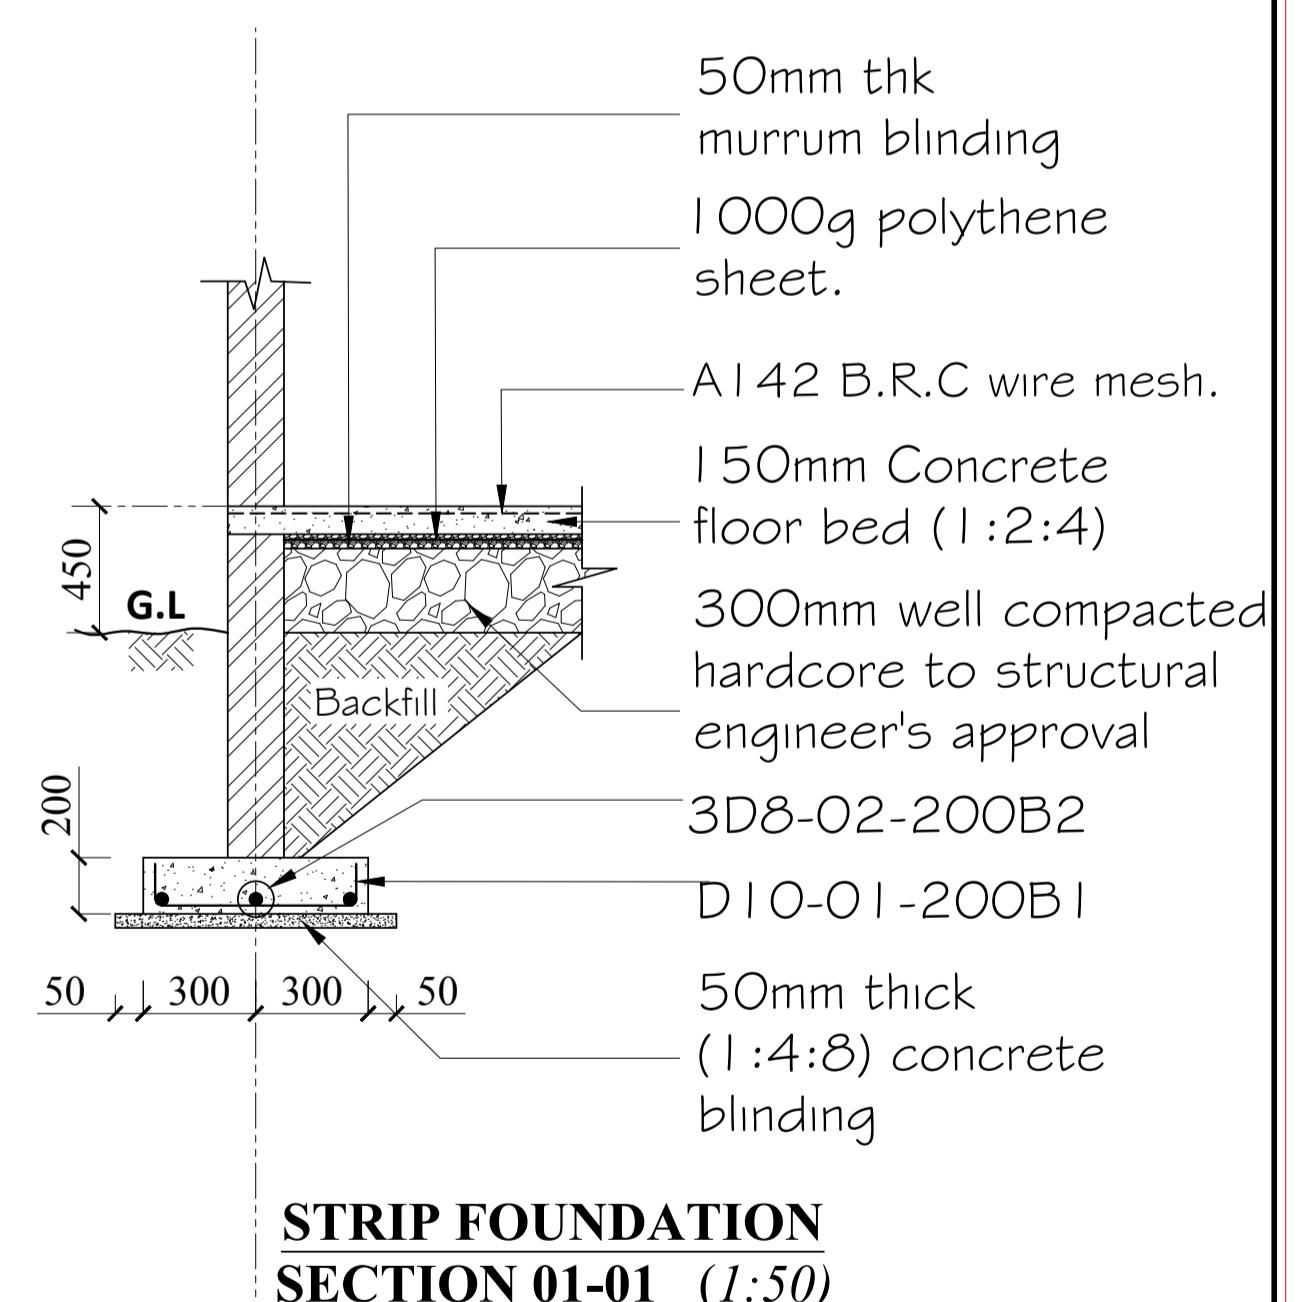
Ring Beam Beam
Section through Ring beam
(Scale 1:25)

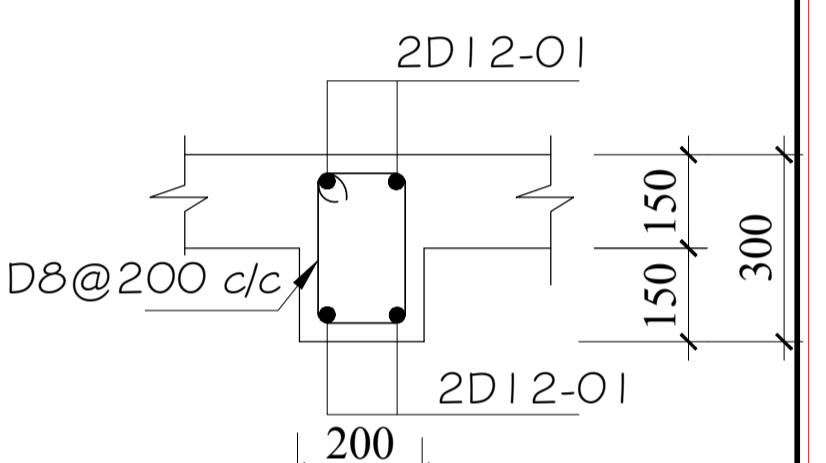

FLOOR PLAN LAYOUT
(Scale= 1:50)







STRIP FOUNDATION LAYOUT
(Scale= 1:50)

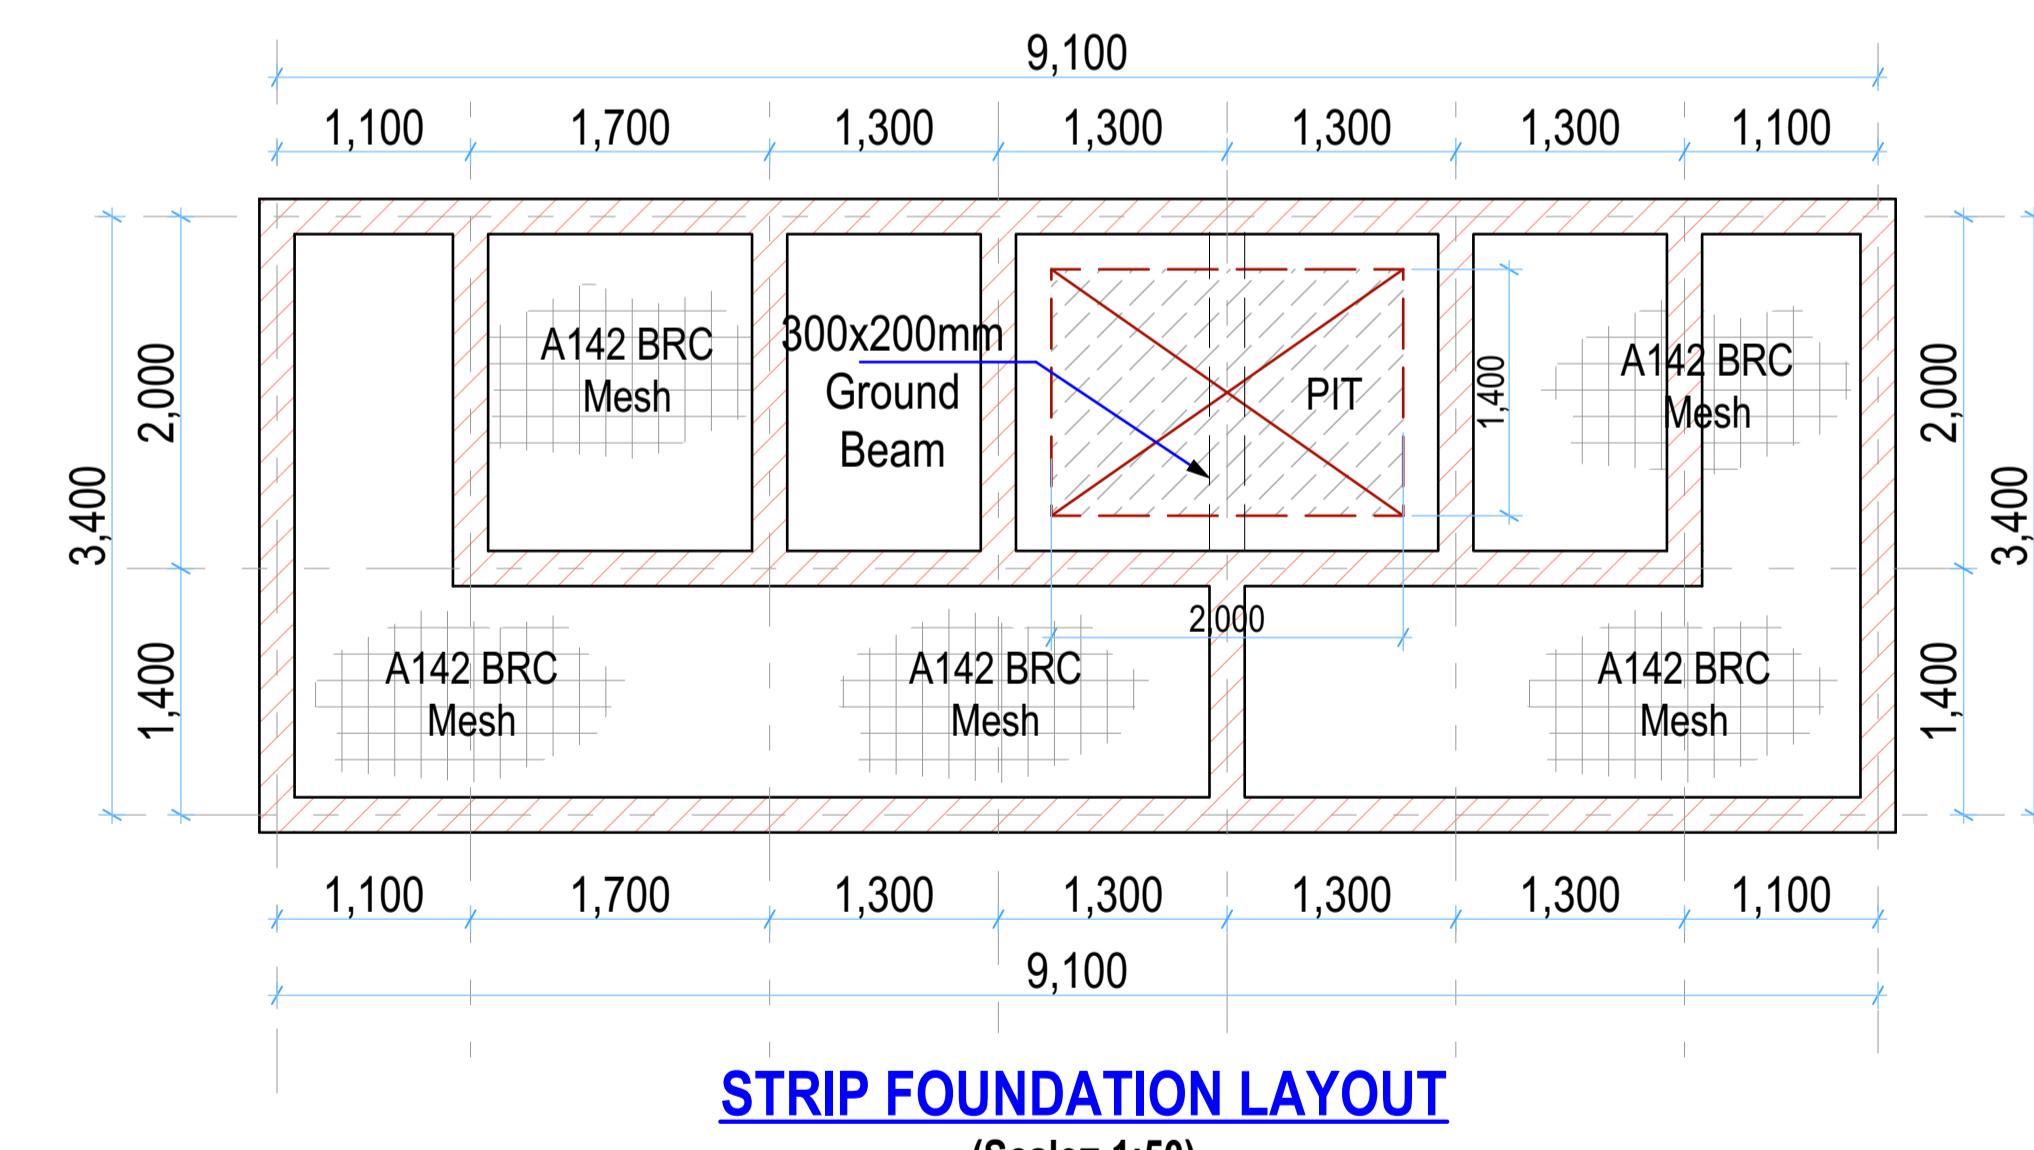

STRIP FOUNDATION
SECTION 01-01 (1:50)

REV.	DESCRIPTION:	DATE:	DRAWN BY:	DESIGNED BY:	CLIENT:	PROJECT: PROPOSED SIRWA AGGREGATION CENTER IN MOGOTIO CONSTITUENCY, BARINGO COUNTY
A.	FIRST ISSUE	DEC, 2024	Francis K. Ngigi	1. Eng. Amos Kiptanui	State Department of Agriculture Ministry of Agriculture and Livestock Development, Cathedral Road, Nairobi P. O. Box 30028-00100 Nairobi- Kenya	TITLE: (PIT LATRINES) Floor Plan Layout, Sections, Elevations and Structural details
				2. Eng. Laban Kiplagat	DRG NO: MoALD/SIR/006	
				3. Eng. Laban Kiplagat	SCALE: As Shown	
				4. Eng. Laban Kiplagat	Contract NO: A Sheet	

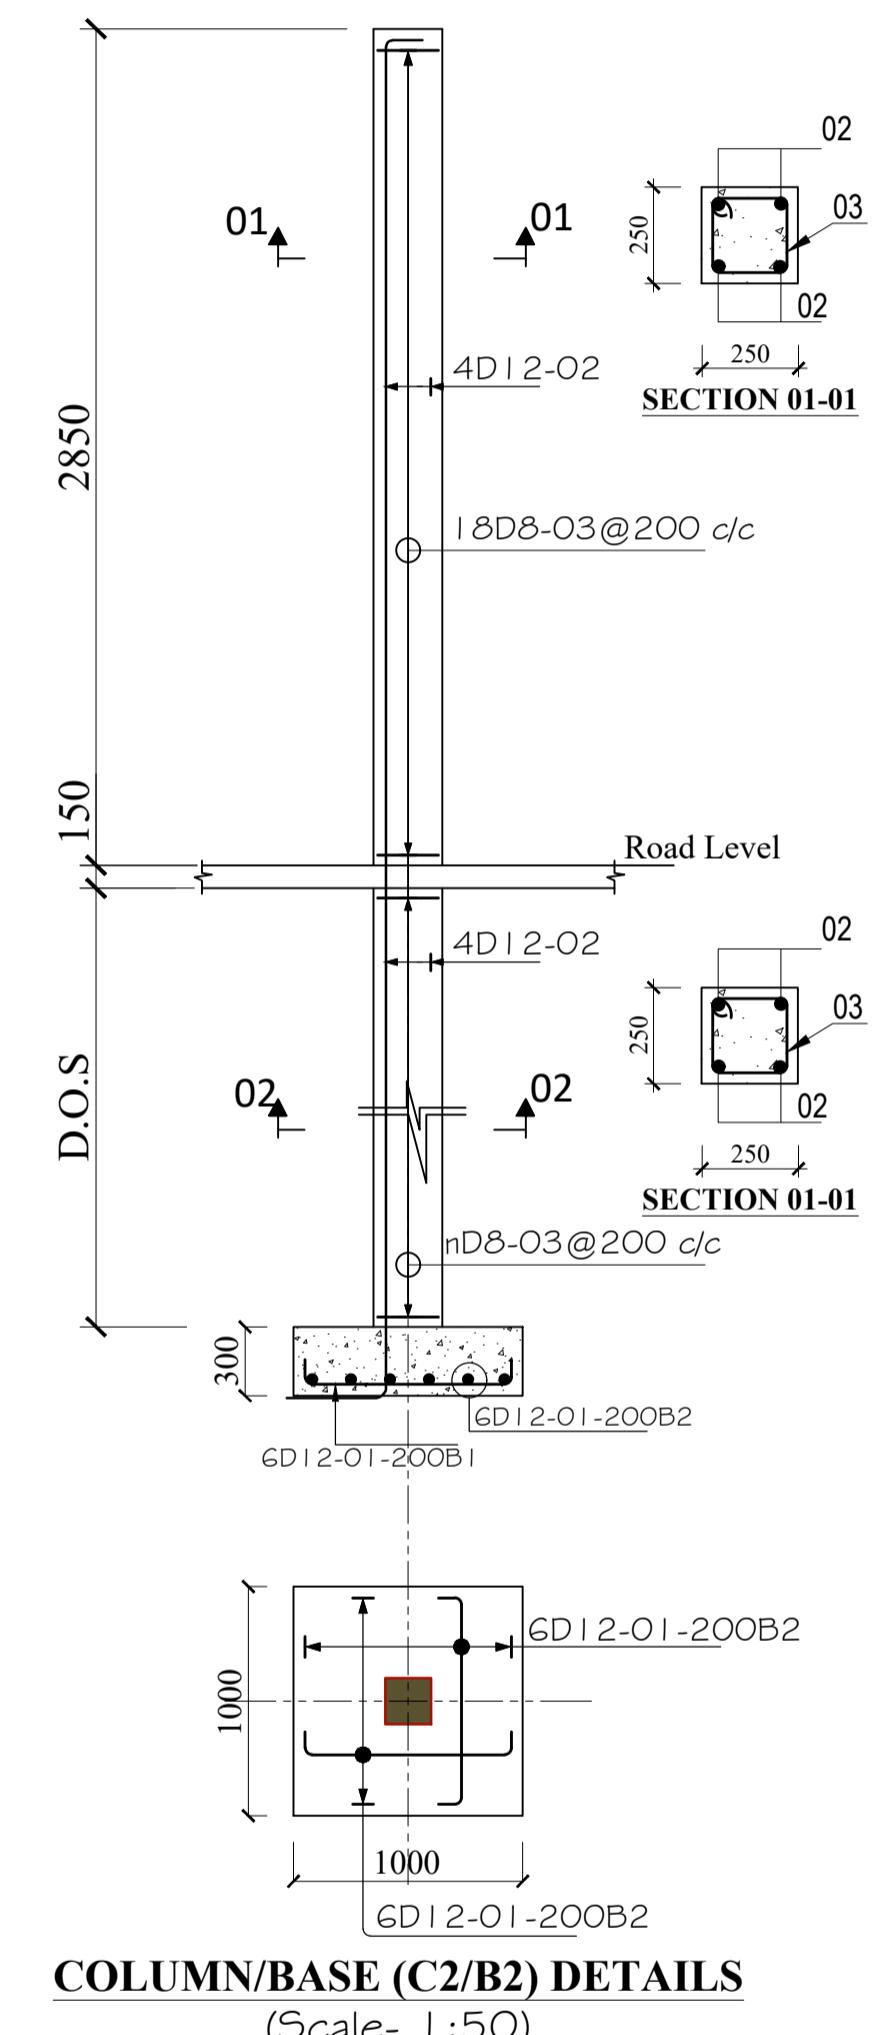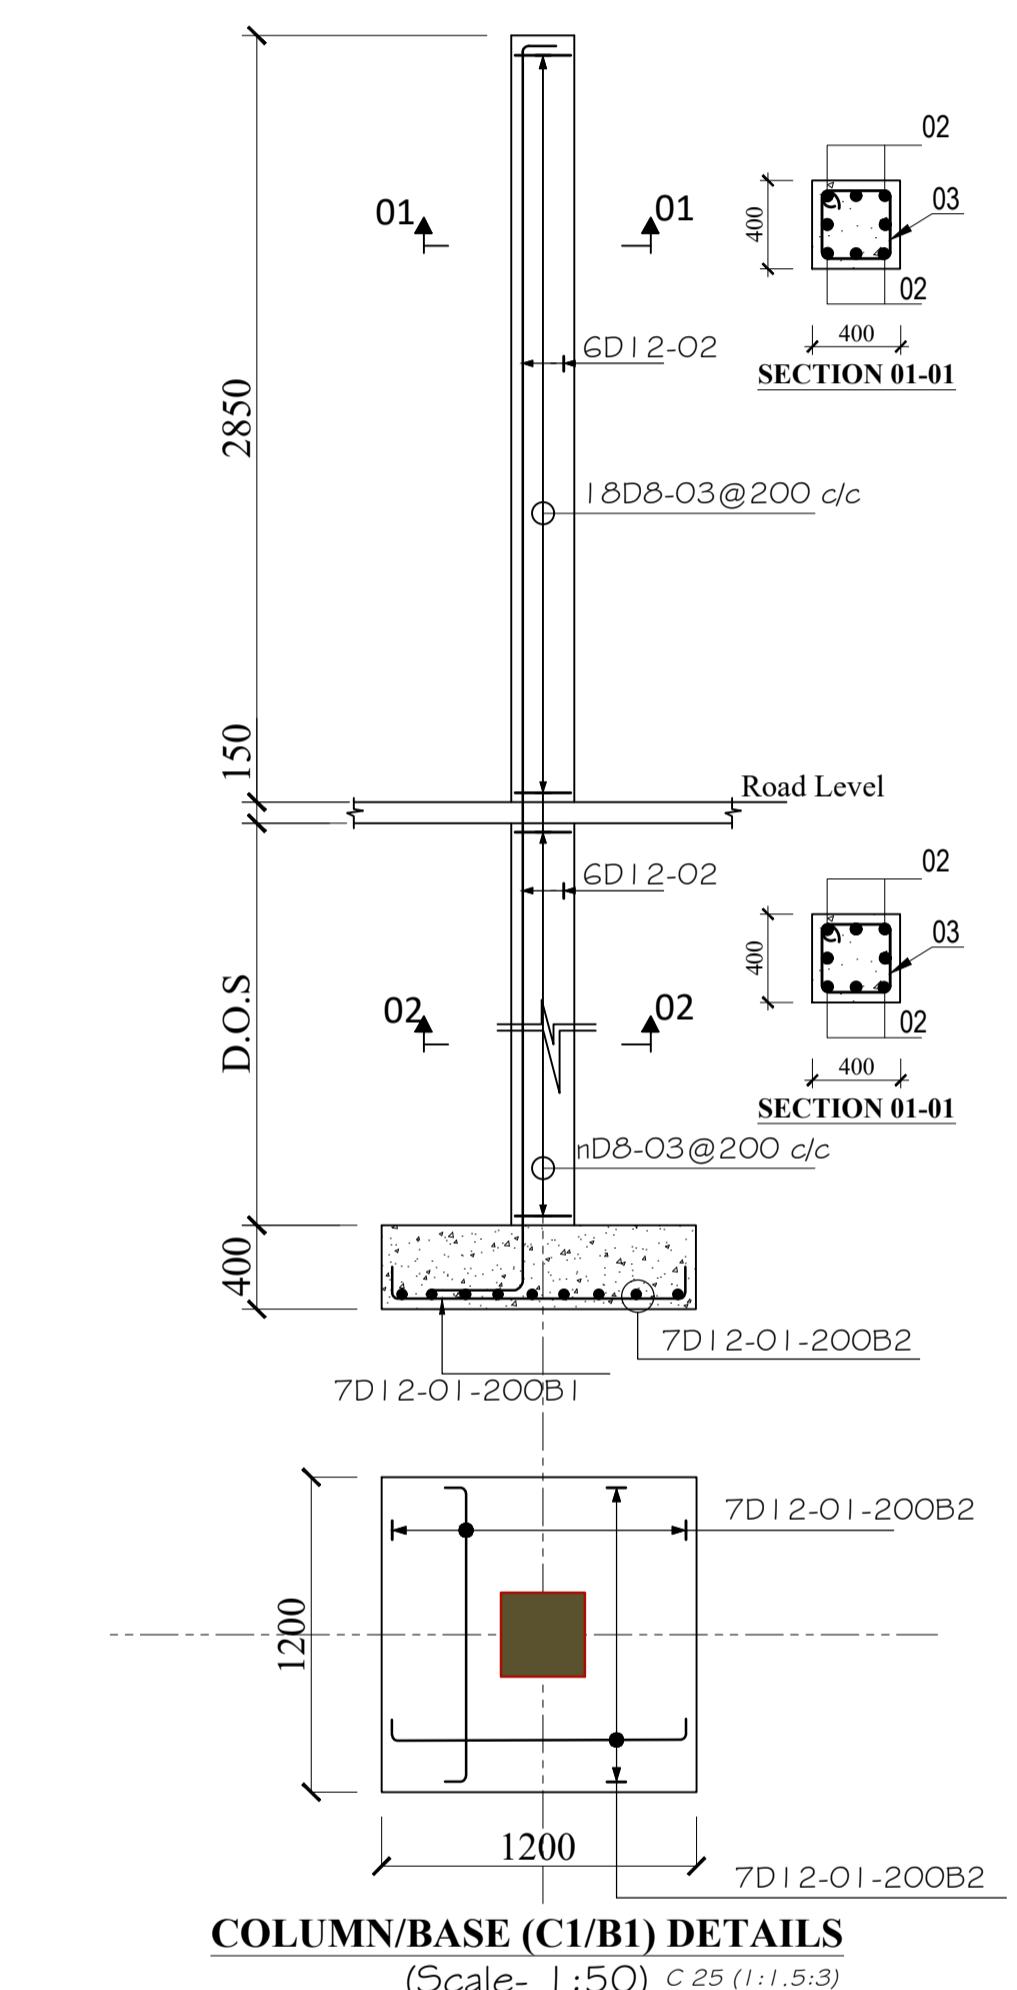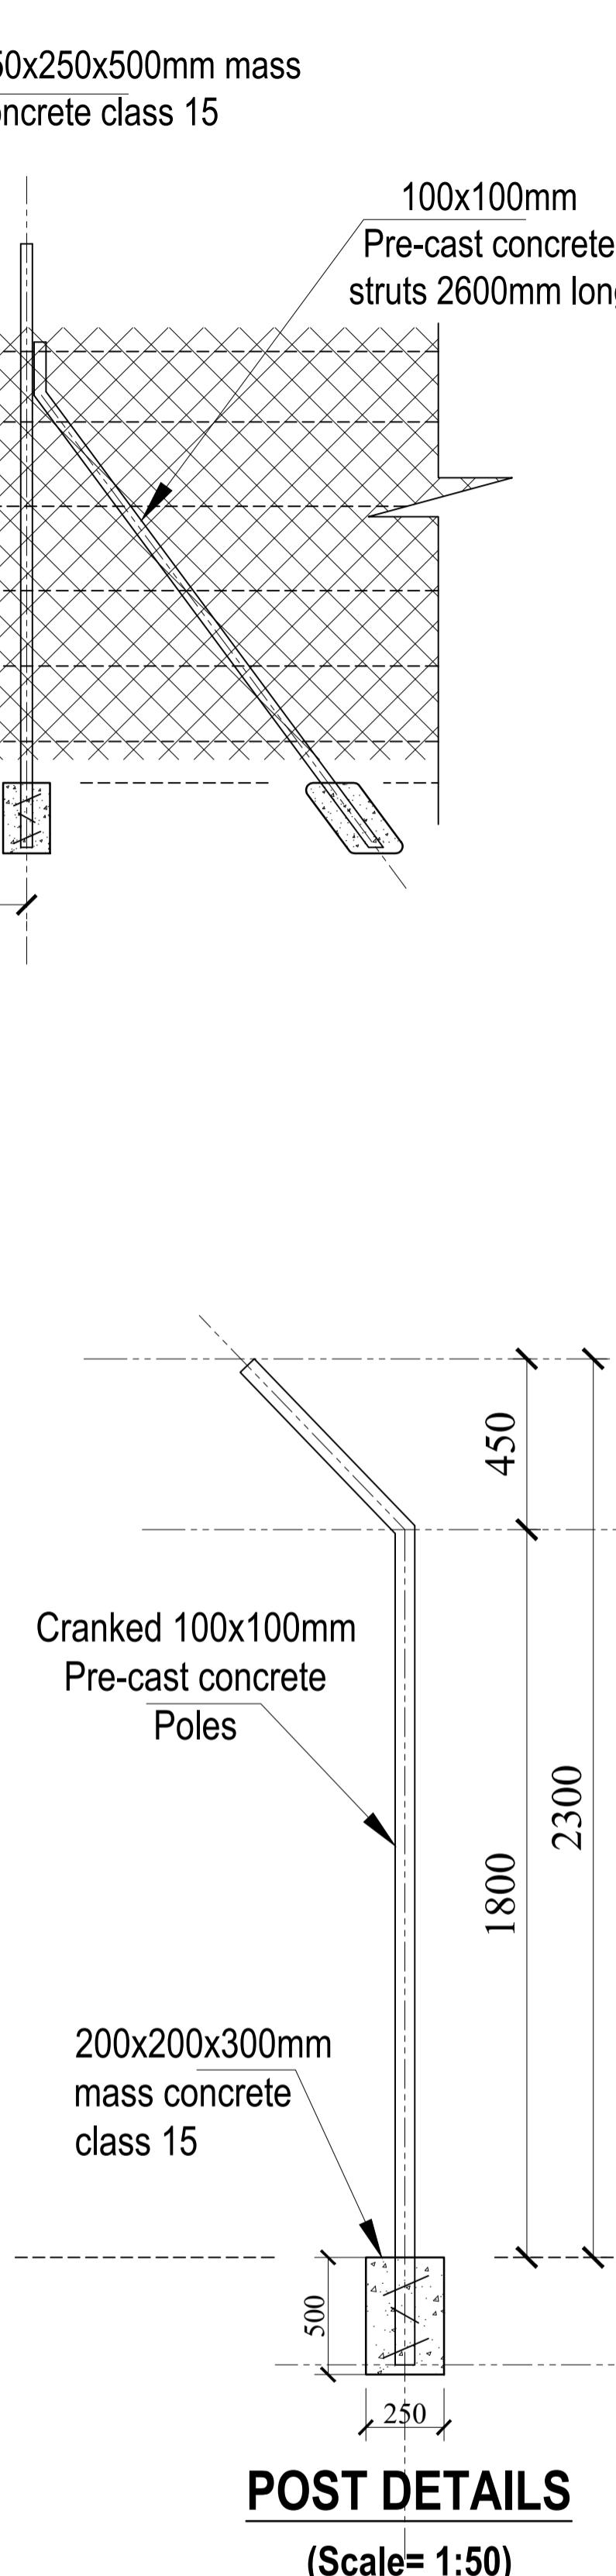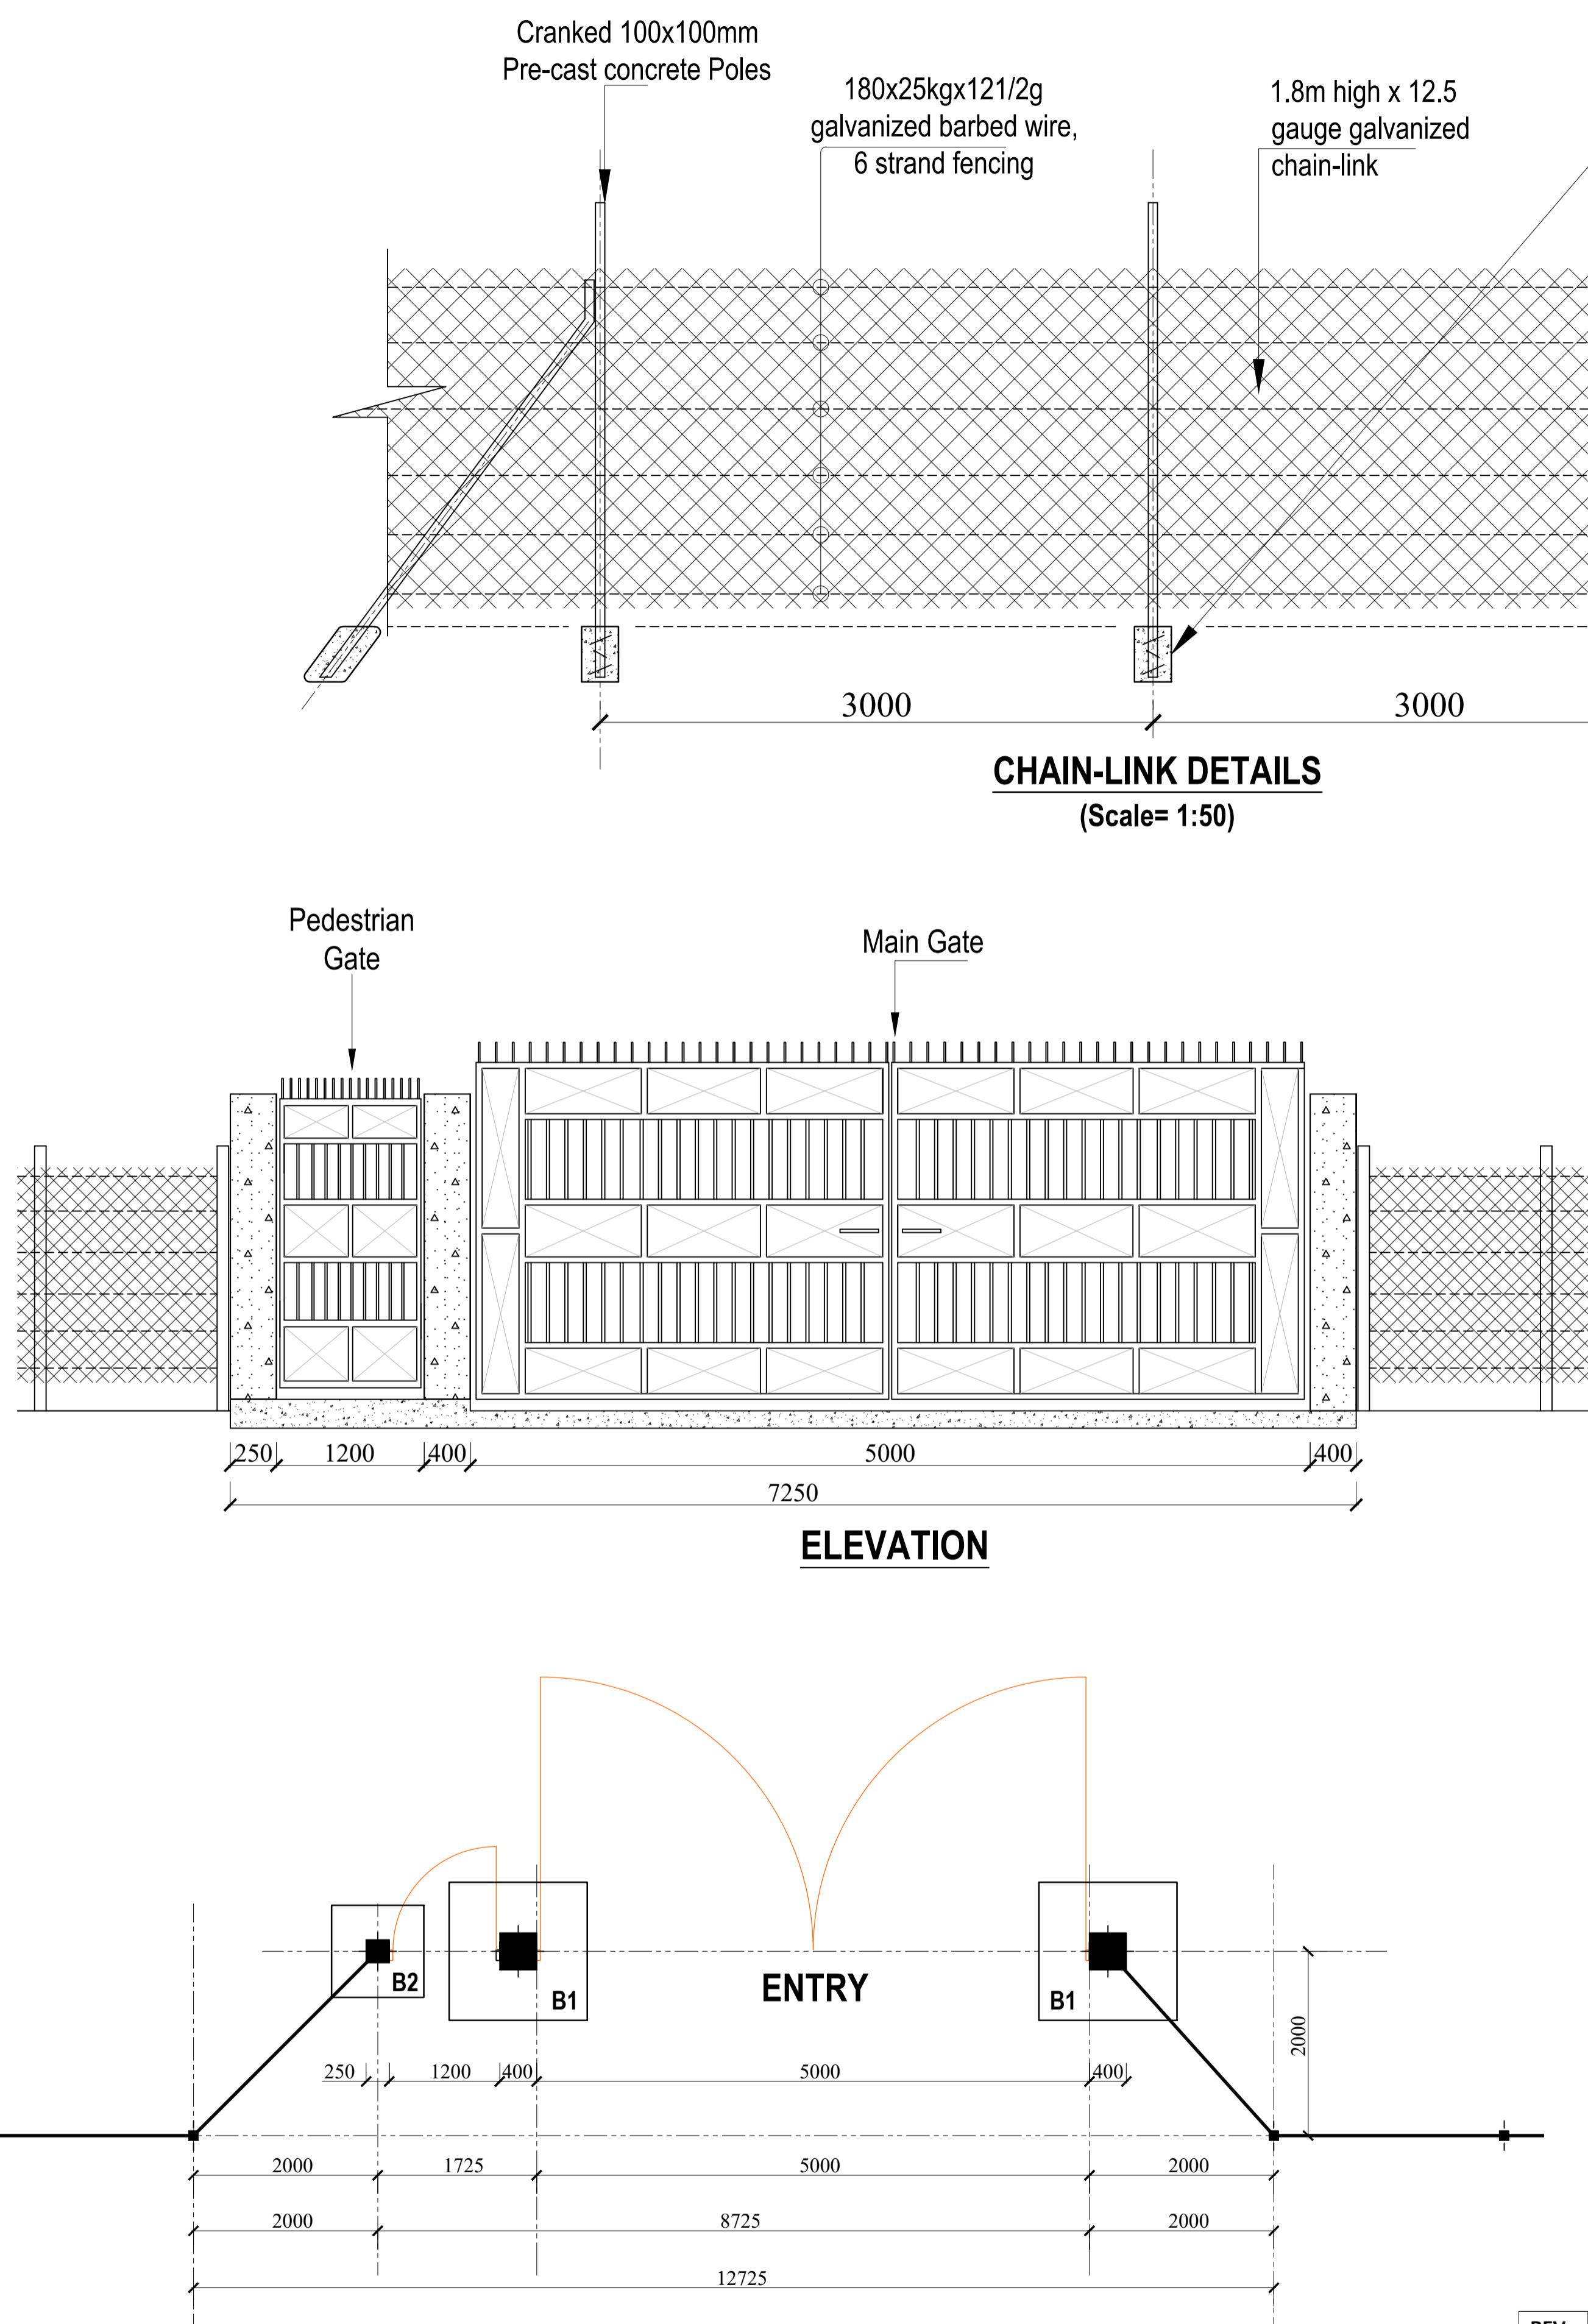

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A.	FIRST ISSUE	DEC, 2024	Francis K. Ngigi	1. Eng. Amos Kiptanui	State Department of Agriculture Ministry of Agriculture and Livestock Development, Cathedral Road, Nairobi P. O. Box 30028-00100 Nairobi- Kenya	TITLE: CHAIN LINK FENCE AND GATE DETAILS				
						DRG NO: MoALD/SIR/007				
				CHECKED BY:	1. Eng. Laban Kiplagat	SCALE: 1:100				
						Contract NO:				
						Sheet:				
						N. Sheet:				